MAIN STREET INDUSTRAIL BUILDING 18501 MAIN STREET CARSON, CA 90746

for: SSH HOLDINGS, LLC

126'-8"

126'-8"

NOTE: SITE PLAN SHALL MEET ALL ENGINEERING & NPDES REQUIREMENTS

EXISTING BLDG.

SSH HOLDINGS, LLC

OWNER

1460 W. FRANCISCO STREET LOS ANGELES, CA 90501 Contact: HERBERT LEE PROJECT MANAGER

PHONE: (949) 400-7676

ARCHITECT

MSA

23112 ALCALDE, SUITE "B" LAGUNA HILLS, CA 92653 (949) 584-5426 FAX: (949) 788-5210 Contact: MICHAEL SCHAFER PRESIDENT mschafer@msa-corp.net

PARKING SUMMARY

Ground Floor Offices, Storage Mezzanine, Manufacturing and Warehouse Ground Floor Office :300 (1 space per 300 Suite A 2,680 SF juare feet of gross Suite B 1,000 SF Storage Mezzanine Suite A (No Suite B

| 33,654 | | | required TOTAL provided: 46 | |
|-----------------------------------|---|---|---|--|
| oor Offices, Of | fice Mezzanine and W | arehouse Parking Ratio | No. of Parking Spaces | |
| | Auditor Manufacture Construction (Construction) | | Required | |
| Floor Office .680 SF 000 SF | 3,680 | 1:300 (1 space per 300 square feet of gross floor area) | 12 | |
| ezzanine nd B | 3,500 | 1:300 | 12 | |
| uring | 0 | 1:500 | 0 | |
| se | 26,474 | 1:1,500 | 18 | |
| | 33,654 | | 42 parking spaces required TOTAL provided: 46 | |

** 12 IS 25% OF TOTAL PARKING, PER CITY OF CARSON GREEN CODE. LETS ADD A NOTE: 12 (3 EV AND 9 FUTURE EV STALL)

TRANSFORMER

W/6"X5H SCREEN WALL

-EXISTING BLDG.

INDUSTRAIL BUILDING - SITE PLAN

ZERO LOT LINE

190'-0"

SITE / BUILDING DATA SITE DATA: 68,889 SF (1.58 ACRES) BUILDING AREA: 30,464 SF (FOOTPRINT)

Lot COVERAGE: 44.22 % • FLOOR TO AREA RATIO: LANDSCAPE INTERIOR PARKING AREA = 10,397 SF

MIN. 5% LANDSCAPE = 520 SF LANDSCAPE AREA: 5,654 SF LANDSCAPE COVERAGE: 8.2 % 32,771 S.F. = 47.5 %% HARDSCAPE COVERAGE:

BUILDING AREA:

2,680 SF 2,500 SF MEZZANINE FLOOR WAREHOUSE/MANUFACTURING 15,302 SF 20,482 SF *1,000 SF WAREHOUSE/MANUFACTURING 11,172 SF

13,172 SF ** MEZZANINE AREA IS LESS THAN 1/3 OF THE AREA OF THE FLOOR IT IS ON ANI

| 2.0.10 2.0.2012.1 00.10.02. | |
|------------------------------|-------------|
| TYP OF CONSTRUCTION: | III-B |
| SPRINKLERED: | YES - ESFR |
| ALLOWABLE HEIGHT (503) | 75' |
| ALLOWABLE # OF STORIES(503) | 3 |
| BASIC ALLOWABLE AREA (CHAP5) | 70,000 S.F. |

SITE LEGEND

POLE MOUNTED LIGHT FIXTURE, SEE ELECTRICAL DRAWINGS. FOR BASE DETAIL SEE 20/A8.1a. WALLPACK LIGHT FIXTURE, SEE ELECTRICAL

TRANSFORMER WITH CONCRETE PAD. SEE

DOCK HIGH TRUCK DOOR

FIRE HYDRANT (VERIFY LOCATION WITH CIVIL P.I.V. WITH TAMPER, SEE FIRE PROTECTION

PROVIDED ELECTRIC VEHICLE STALL (3 STALLS) LEVEL TWO OR LEVEL 3 CHARGER (DC FAST CHARGE)

FUTURE ELECTRIC VEHICLE STALL (9 STALLS) PROVIDE CODUIT AND JBOX AS REQUIRED.

SITE PLAN GENERAL NOTES

REFER TO LANDSCAPE DRAWING FOR CONCRETE WALKS, PAVING, BERMS, LANDSCAPING AND IRRIGATION.

BASINS, PAVING DETAILS, SITE UTILITIES, CURB AND GUTTER SWALES

FIRE HYDRANTS SHALL BE INSTALLED IN ACCORDANCE WITH THE LOCAL FIRE DEPARTMENT STANDARDS.

FIRE DEPARTMENT STANDARDS.

AUTOMATIC FIRE SPRINKLER SYSTEMS SHALL BE DESIGNED IN

B. NFPA 13 231 - GENERAL STORAGE C. NFPA 231C - RACK STORAGE OF MATERIALS

DENOTES PARKING STALL FOR THE PHYSICALLY DISABLED (9'-0" WIDE X 18'-0" LONG) WITH A 5'-0" WIDE LOADING AREA. PROVIDE AN 8'-0" WIDE LOADING AREA AT VAN

9. FIRE LANE TO BE CONTINUOUSLY PAVED TO ACCOMMODATE 40,000

12. ALL DIMENSIONS ARE TO BE FACE OF CONCRETE WALL, FACE OF

VICINITY MAP

CONCRETE CURB, PROPERTY LINE, OR CENTERLINE OF PARKING STALL UNLESS NOTED OTHERWISE. 14. REFER TO CIVIL DRAWINGS FOR POINT OF CONNECTIONS TO OFF-SITE UTILITIES. CONTRACTOR TO VERIFY ACTUAL UTILITY LOCATIONS. 5. CONCRETE WALK SHALL RECEIVE EXPANSION JOINTS AT 15'-0" O.C. MAX. AND CONTROL JOINTS AT 15'-0" O.C. MAX. AND CONTROL JOINTS AT 5'-0" O.C. BETWEEN EXPANSION JOINTS UNLESS NOTED

METAL GATE County of Los Angeles Fire Department Fire Prevention Division **Land Development Unit** ______ RECYCLE A. FRONT ENTRY ELEV D. SIDE **B. SIDE ENTRY** C. REAR ELEVATION 10'-0" TRASH ENCLOSURE PLAN & ELEVATIONS **County of Los Angeles Fire Department Fire Prevention Division EXISTING BLDG. NIC Land Development Unit Public** Install ___ **Private** 6"x 4"x 2 1/2" Fire Hydrants 132'-6" - PATH OF **Confirming to American Waterworld** 51'-0" **Association Standard C503 TRAVEL** REQUIRED FIRE FLOW PRIVATE DRIVEWAY AND FIRE LANE 2,000 **GPM @ 20PSI FOR** 2 HOURS 10 STALLS @ 8'-6"=85'-0" EXISTING FIRE HYDRANT -TRASH TRASH **ENCLOSURE ENCLOSURE** PATH OF **TRAVEL** ZERO LOT LINE SUITE B SUITE A 13,172 SF 20,482 SF

ELECTRICAL DRAWINGS. (PROVIDE PROTECTION BOLLARDS PER LOCAL UTILITY OR PUBLIC WORK

28' WIDE FIRE LANE (HATCHED),

PARKING STALL COUNT TOTAL.

GRADE LEVEL TRUCK DOOR

REFER TO CIVIL DRAWINGS FOR SITE GRADING, DRAINAGE, CATCH

PLANS FOR FIRE HYDRANTS AND FIRE SPRINKLERS MUST BE REVIEWED AND APPROVED BY THE FIRE DEPARTMENT.

5. 🕁 DENOTES FIRE HYDRANT LOCATION WITH BOLLARDS PER LOCAL

ACCORDANCE WITH THE FOLLOWING STANDARD(S): A. NFPA 13 — COMMERCIAL

ALL PARKING STALL STRIPING SHALL BE PER LOCAL JURISDICTION

10. FIRE LANE SHALL HAVE A MINIMUM VERTICAL CLEARANCE OF 13'-6". 11. SITE DRAINAGE SHALL NOT FLOW ACROSS PEDESTRIAN WALKWAYS.

13. PROVIDE POSITIVE DRAINAGE AWAY FROM BUILDING. REFER TO CIVIL

REVIEWED BY: MSA JOB NO.: SITE PLAN

PLAN ISSUE DATES REV. DATE DESCRIPTION

06-17-21 RE-SUBMITTAL

Planning SUBMITTAL

PROFESSIONAL STAMP

CONSULTANT

PROJECT SITE -

DATE OF FIELD SURVEY

TAX PARCEL NO. 7339-013-009

TITLE INFORMATION

JULY 23, 2020.

THE TITLE INFORMATION SHOWN HEREON IS PER PRELIMINARY REPORT FOR TITLE INSURANCE NO. 00700393-997-BOC DATED MAY 13, 2020 AS PREPARED BY TICOR TITLE, NEWPORT BEACH, CA [TITLE OFFICER: BOB TAYLOR, TELEPHONE: (714) 289-6402]. NO RESPONSIBILITY OF CONTENT, COMPLETENESS OR ACCURACY OF SAID PRELIMINARY REPORT IS ASSUMED BY THIS MAP OR THE SURVEYOR.

RECORD OWNER

ROBERT SAN-KUIE HSU, TRUSTEE OF THE SURVIVOR'S TRUST UNDER THE HSU FAMILY TRUST ESTABLISHED AUGUST 04, 1995, AS TO AN UNDIVIDED 50.00% INTEREST;

ROBERT SAN-KUIE HSU, TRUSTEE OF THE NON-GST EXEMPT MARITAL TRUST UNDER THE HSU FAMILY TRUST ESTABLISHED AUGUST 04, 1995, AS TO AN UNDIVIDED 36.6167% INTEREST; AND

ROBERT SAN-KUIE HSU, TRUSTEE OF THE CREDIT TRUST UNDER THE HSU FAMILY TRUST ESTABLISHED AUGUST 04, 1995, AS TO AN UNDIVIDED 13.3833% INTEREST.

LEGAL DESCRIPTION

A-B TAXES

PUBLIC RECORDS.

THE LAND REFERRED TO HEREIN BELOW IS SITUATED IN THE COUNTY OF LOS ANGELES, STATE OF CALIFORNIA, AND IS DESCRIBED AS FOLLOWS:

THAT PORTION OF THE NORTH HALF OF LOT 122 OF TRACT 4671, IN THE CITY OF CARSON, COUNTY OF LOS ANGELES, STATE OF CALIFORNIA, AS PER MAP RECORDED IN BOOK 56, PAGE 30 OF MAPS, IN THE OFFICE OF THE COUNTY RECORDER OF SAID COUNTY, LYING EASTERLY OF A LINE EXTENDING SOUTHERLY FROM A POINT IN THE NORTHERLY LINE OF SAID LOT, DISTANT THEREON 422.57 FEET WESTERLY FROM THE NORTHEAST CORNER OF SAID LOT TO A POINT IN THE SOUTHERLY LINE OF SAID NORTH HALF, DISTANT THEREON 423.70 FEET WESTERLY FROM THE EASTERLY LINE OF SAID LOT.

TITLE EXCEPTIONS AND EASEMENTS

- 1 WATER RIGHTS, CLAIMS OR TITLE TO WATER, WHETHER OR NOT DISCLOSED BY THE
- 2 EASEMENT GRANTED TO DOMINGUEZ WATER COMPANY FOR THE PURPOSE OF PUMPING PLANTS, RIGHT OF WAY FOR PIPES AND RIGHTS INCIDENTAL THERETO, AS GRANTED IN A DOCUMENT RECORDED IN BOOK 936, PAGE 287 OFFICIAL RECORDS.

(DOCUMENT AFFECTS - CANNOT BE PLOTTED FROM RECORD)

3 EASEMENT RESERVED BY TITLE INSURANCE AND TRUST COMPANY FOR THE PURPOSE OF POLE LINES AND PIPES AND RIGHTS INCIDENTAL THERETO AS RESERVED IN A DOCUMENT RECORDED IN BOOK 8147, PAGE 98 OFFICIAL RECORDS.

(DOCUMENT AFFECTS - CANNOT BE PLOTTED FROM RECORD)

- 4 EASEMENT GRANTED TO COUNTY OF LOS ANGELES FOR THE PURPOSE OF PUBLIC ROAD AND HIGHWAY AND RIGHTS INCIDENTAL THERETO, AS GRANTED IN A DOCUMENT: RECORDED FEBRUARY 07, 1957 IN BOOK 53582, PAGE 446 OFFICIAL RECORDS.

 (DOCUMENT DOES NOT AFFECT FALLS WITHIN STREET RIGHT—OF—WAY PLOTTED
- 5 TITLE COMPANY STATEMENT.
- 6 NOT A SURVEY ITEM.
- 7 ANY RIGHTS OF THE PARTIES IN POSSESSION OF A PORTION OF, OR ALL OF, SAID LAND, WHICH RIGHTS ARE NOT DISCLOSED BY THE PUBLIC RECORDS.
- 8 TITLE COMPANY STATEMENT.

FLOOD ZONE INFORMATION

THE LAND SHOWN ON THIS SURVEY LIES ENTIRELY WITHIN FLOOD ZONE "X" (SHADED), BEING DESCRIBED AS "AREAS OF 0.2% ANNUAL CHANCE FLOOD; AREAS OF 1% ANNUAL CHANCE FLOOD WITH AVERAGE DEPTHS OF LESS THAN 1 FOOT OR WITH DRAINAGE AREAS LESS THAN 1 SQUARE MILE; AND AREAS PROTECTED BY LEVEES FROM 1% ANNUAL CHANCE FLOOD" PER FLOOD INSURANCE RATE MAP (FIRM) — COMMUNITY PANEL NUMBER 06037C1935F, DATED SEPTEMBER 26, 2008.

TOPOGRAPHIC INFORMATION

THE TOPOGRAPHIC INFORMATION SHOWN HEREON WAS COMPILED PHOTOGRAMMETRICALLY FROM AERIAL PHOTOGRAPHY DATED JULY 24, 2020 BY INLAND AERIAL SURVEYS INC.

BENCHMARK NOTE

THE CONTOURS AND ELEVATIONS SHOWN HEREON ARE BASED ON THE FOLLOWING BENCHMARK:


BM No.: 7Y8479 ELEV.: 26.513' (COUNTY OF LOS ANGELES BENCHMARK)
DATUM: NAVD 88
DESCRIPTION: L&BN IN E CB 19.2M(63') S/O BCR @ SE COR VICTORIA ST & MAIN ST
CONTOUR INTERVAL=1'


BASIS OF BEARINGS


THE BEARINGS SHOWN HEREON ARE BASED ON THE CENTER LINE OF MAIN STREET AS SHOWN ON RECORD OF SURVEY, FILED IN BOOK 298, PAGES 28, BEING NORTH 00°26'30"

MONUMENT AND ESTABLISHMENT NOTES

- INDICATES FOUND MONUMENT AS NOTED BELOW.
- 1) INDICATES FOUND LEAD, TACK, AND TAG PER RECORD OF SURVEY 298/28.
- 2 INDICATES FOUND LEAD AND TACK PER MAP 15195, P.M.B. 163/47.
- (3) INDICATED FOUND LEAD AND TACK, NO REFERENCE. ACCEPTED AS THE ON THE SOUTHERLY PROLONGATION OF THE CENTERLINE OF MAIN STREET.

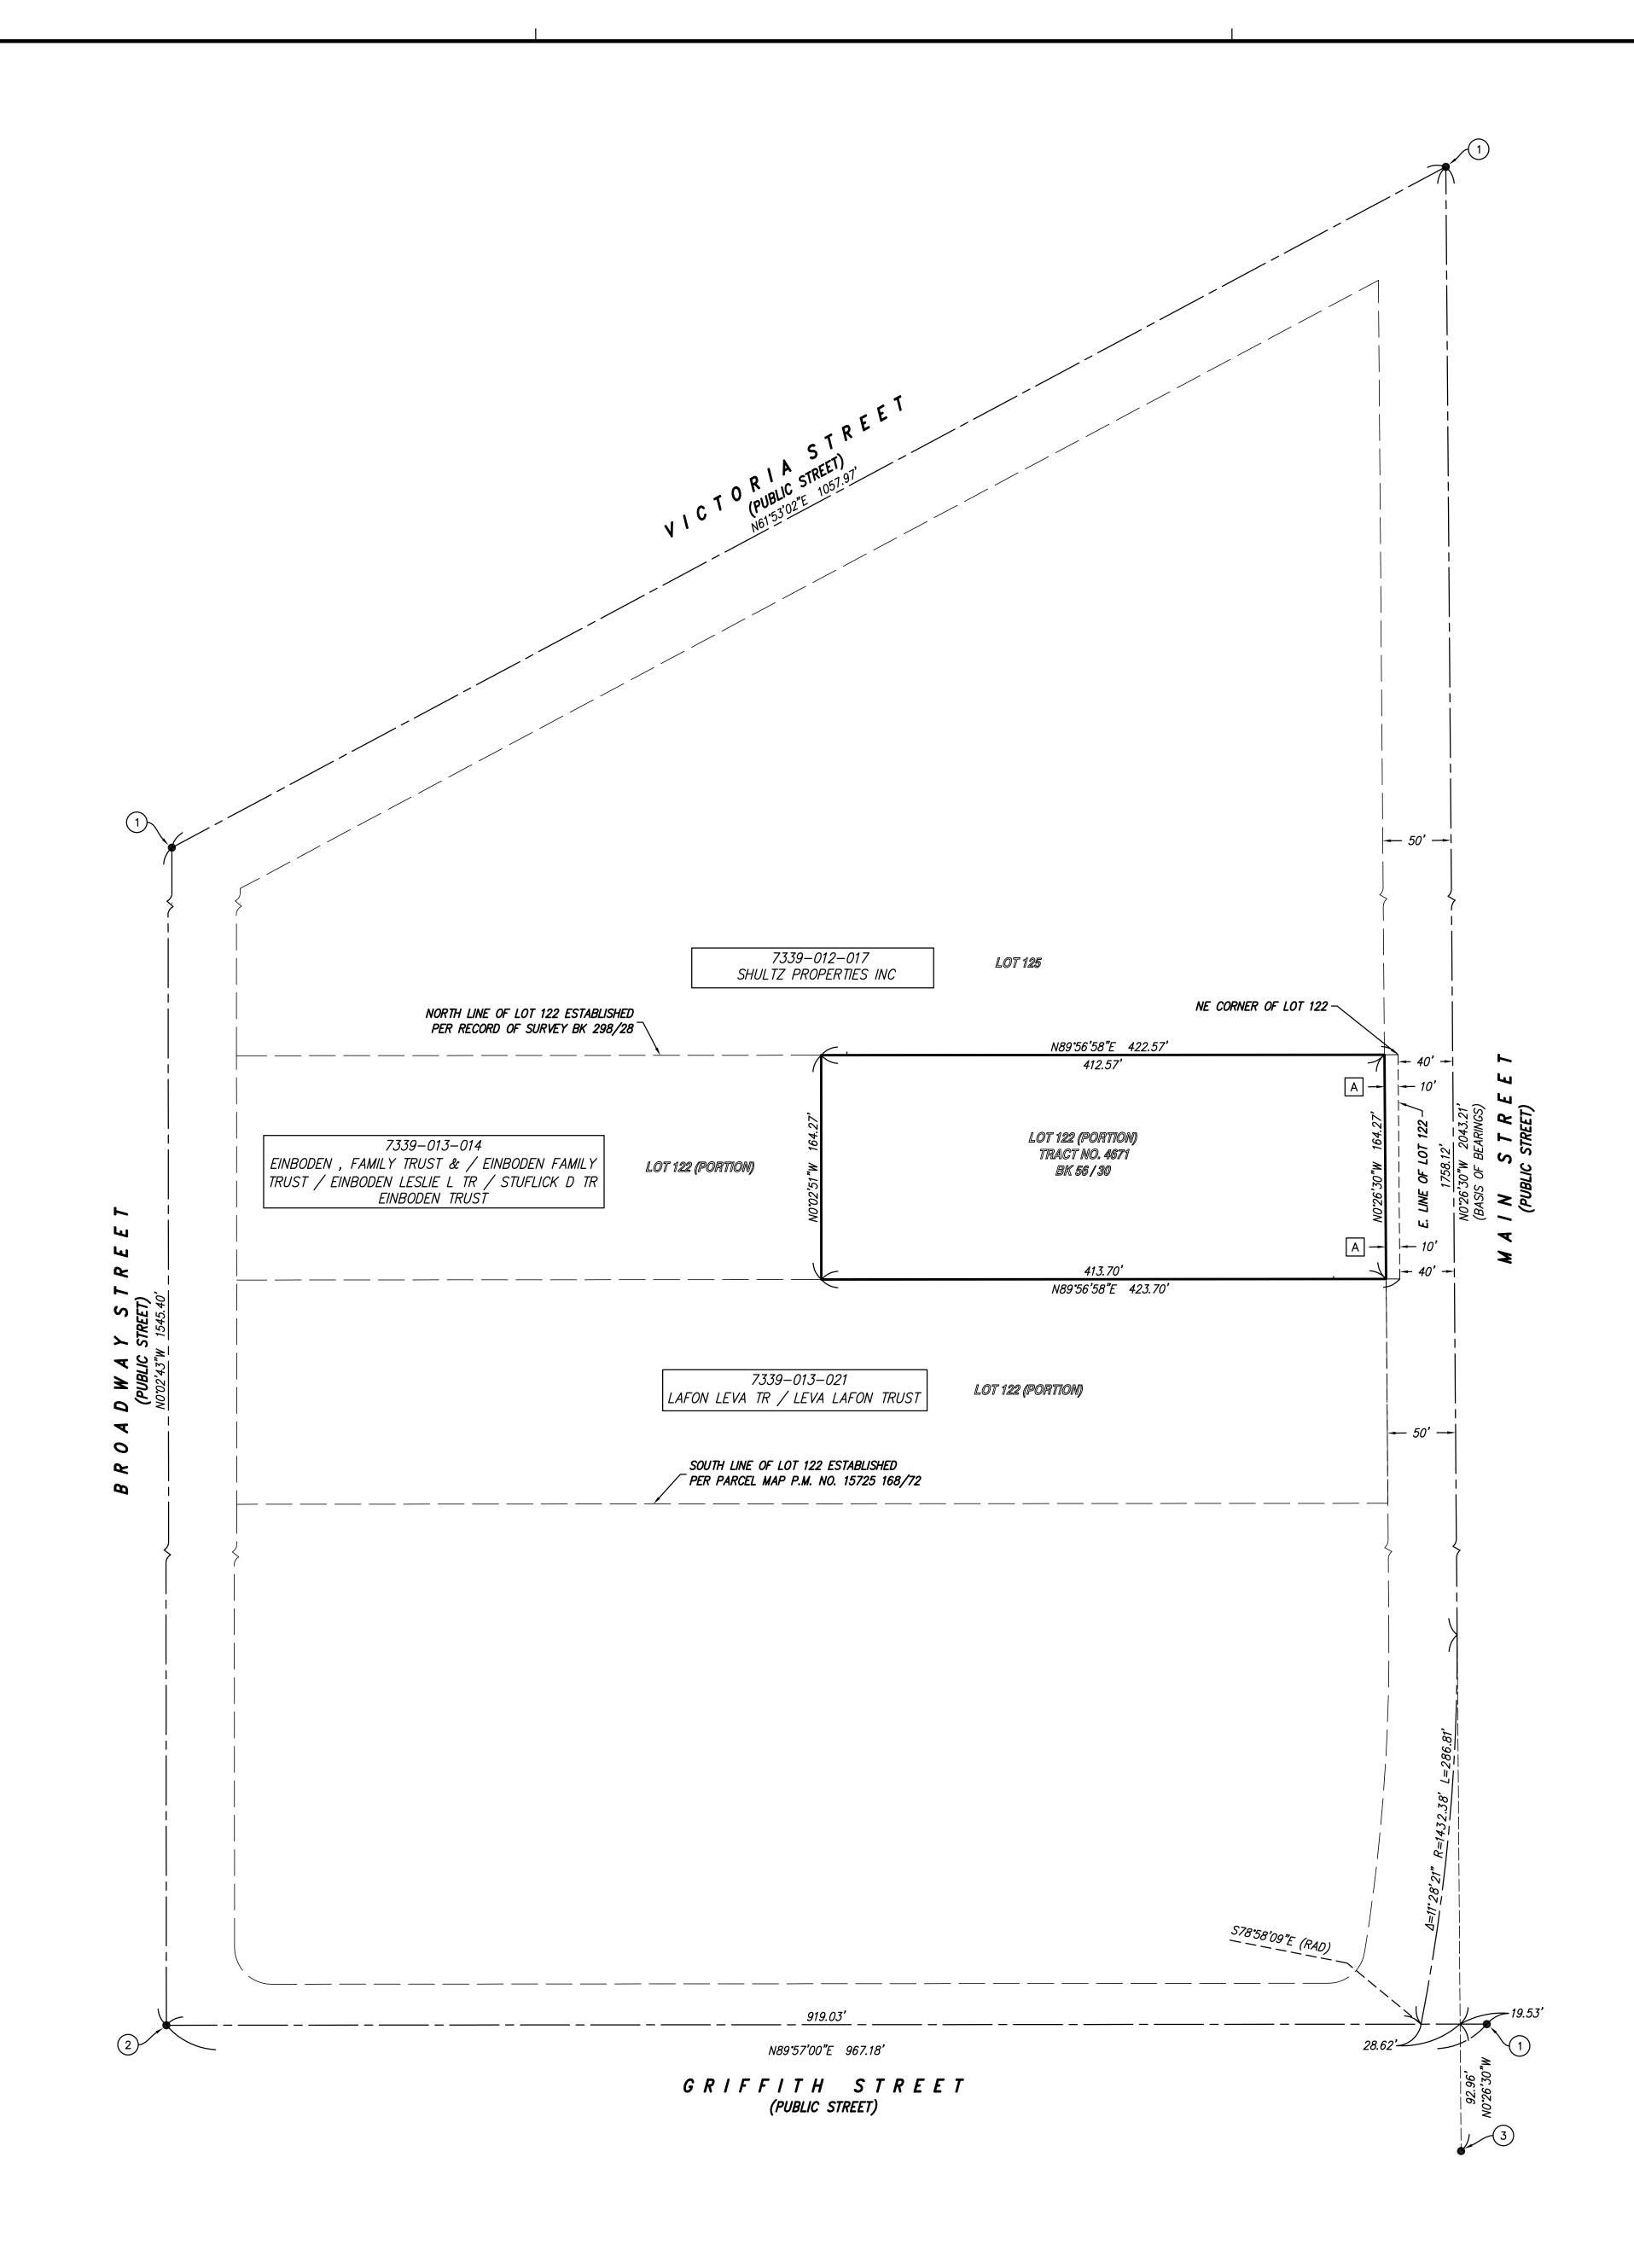

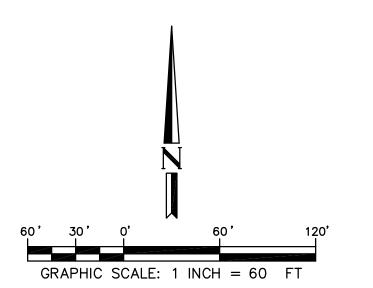

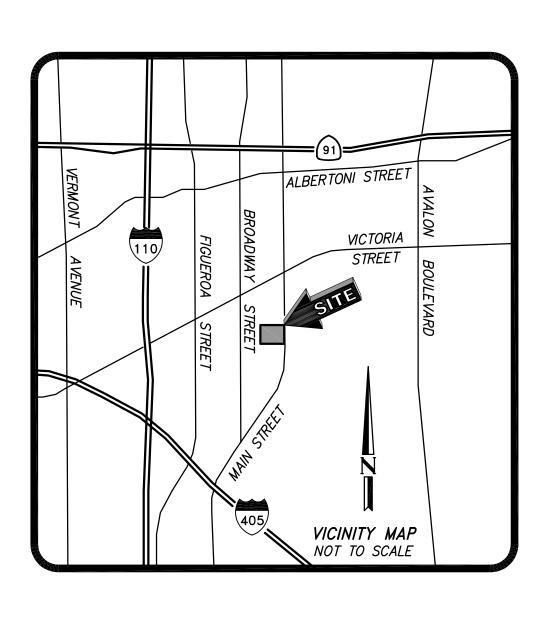

LINE LEGEND

CENTER LINE

UNDERLYING LOT LINE

EASEMENT

PROPERTY LINE



SURVEYOR'S CERTIFICATE

THIS MAP WAS PREPARED BY ME OR UNDER MY SUPERVISION.

PASCAL R. APOTHELOZ, PLS 7734 EMAIL: papotheloz@drc-eng.com

DATE: <u>04/27/2021</u>



IO.: REVISION:

1 ADDED LABELS

DATE:

O4/27/2021

DATE: O8/06/2020

DRAWN: MDS CHECKED: PRA

DRAWN: MDS CHECKED: PRA

DRAWNG FILE: 20-543enc101


PROJECT NO.: 20-543

SHEET NUMBER:


(714) 685-6860

OF 2 SHEETS

SCALE: 1" = 60'

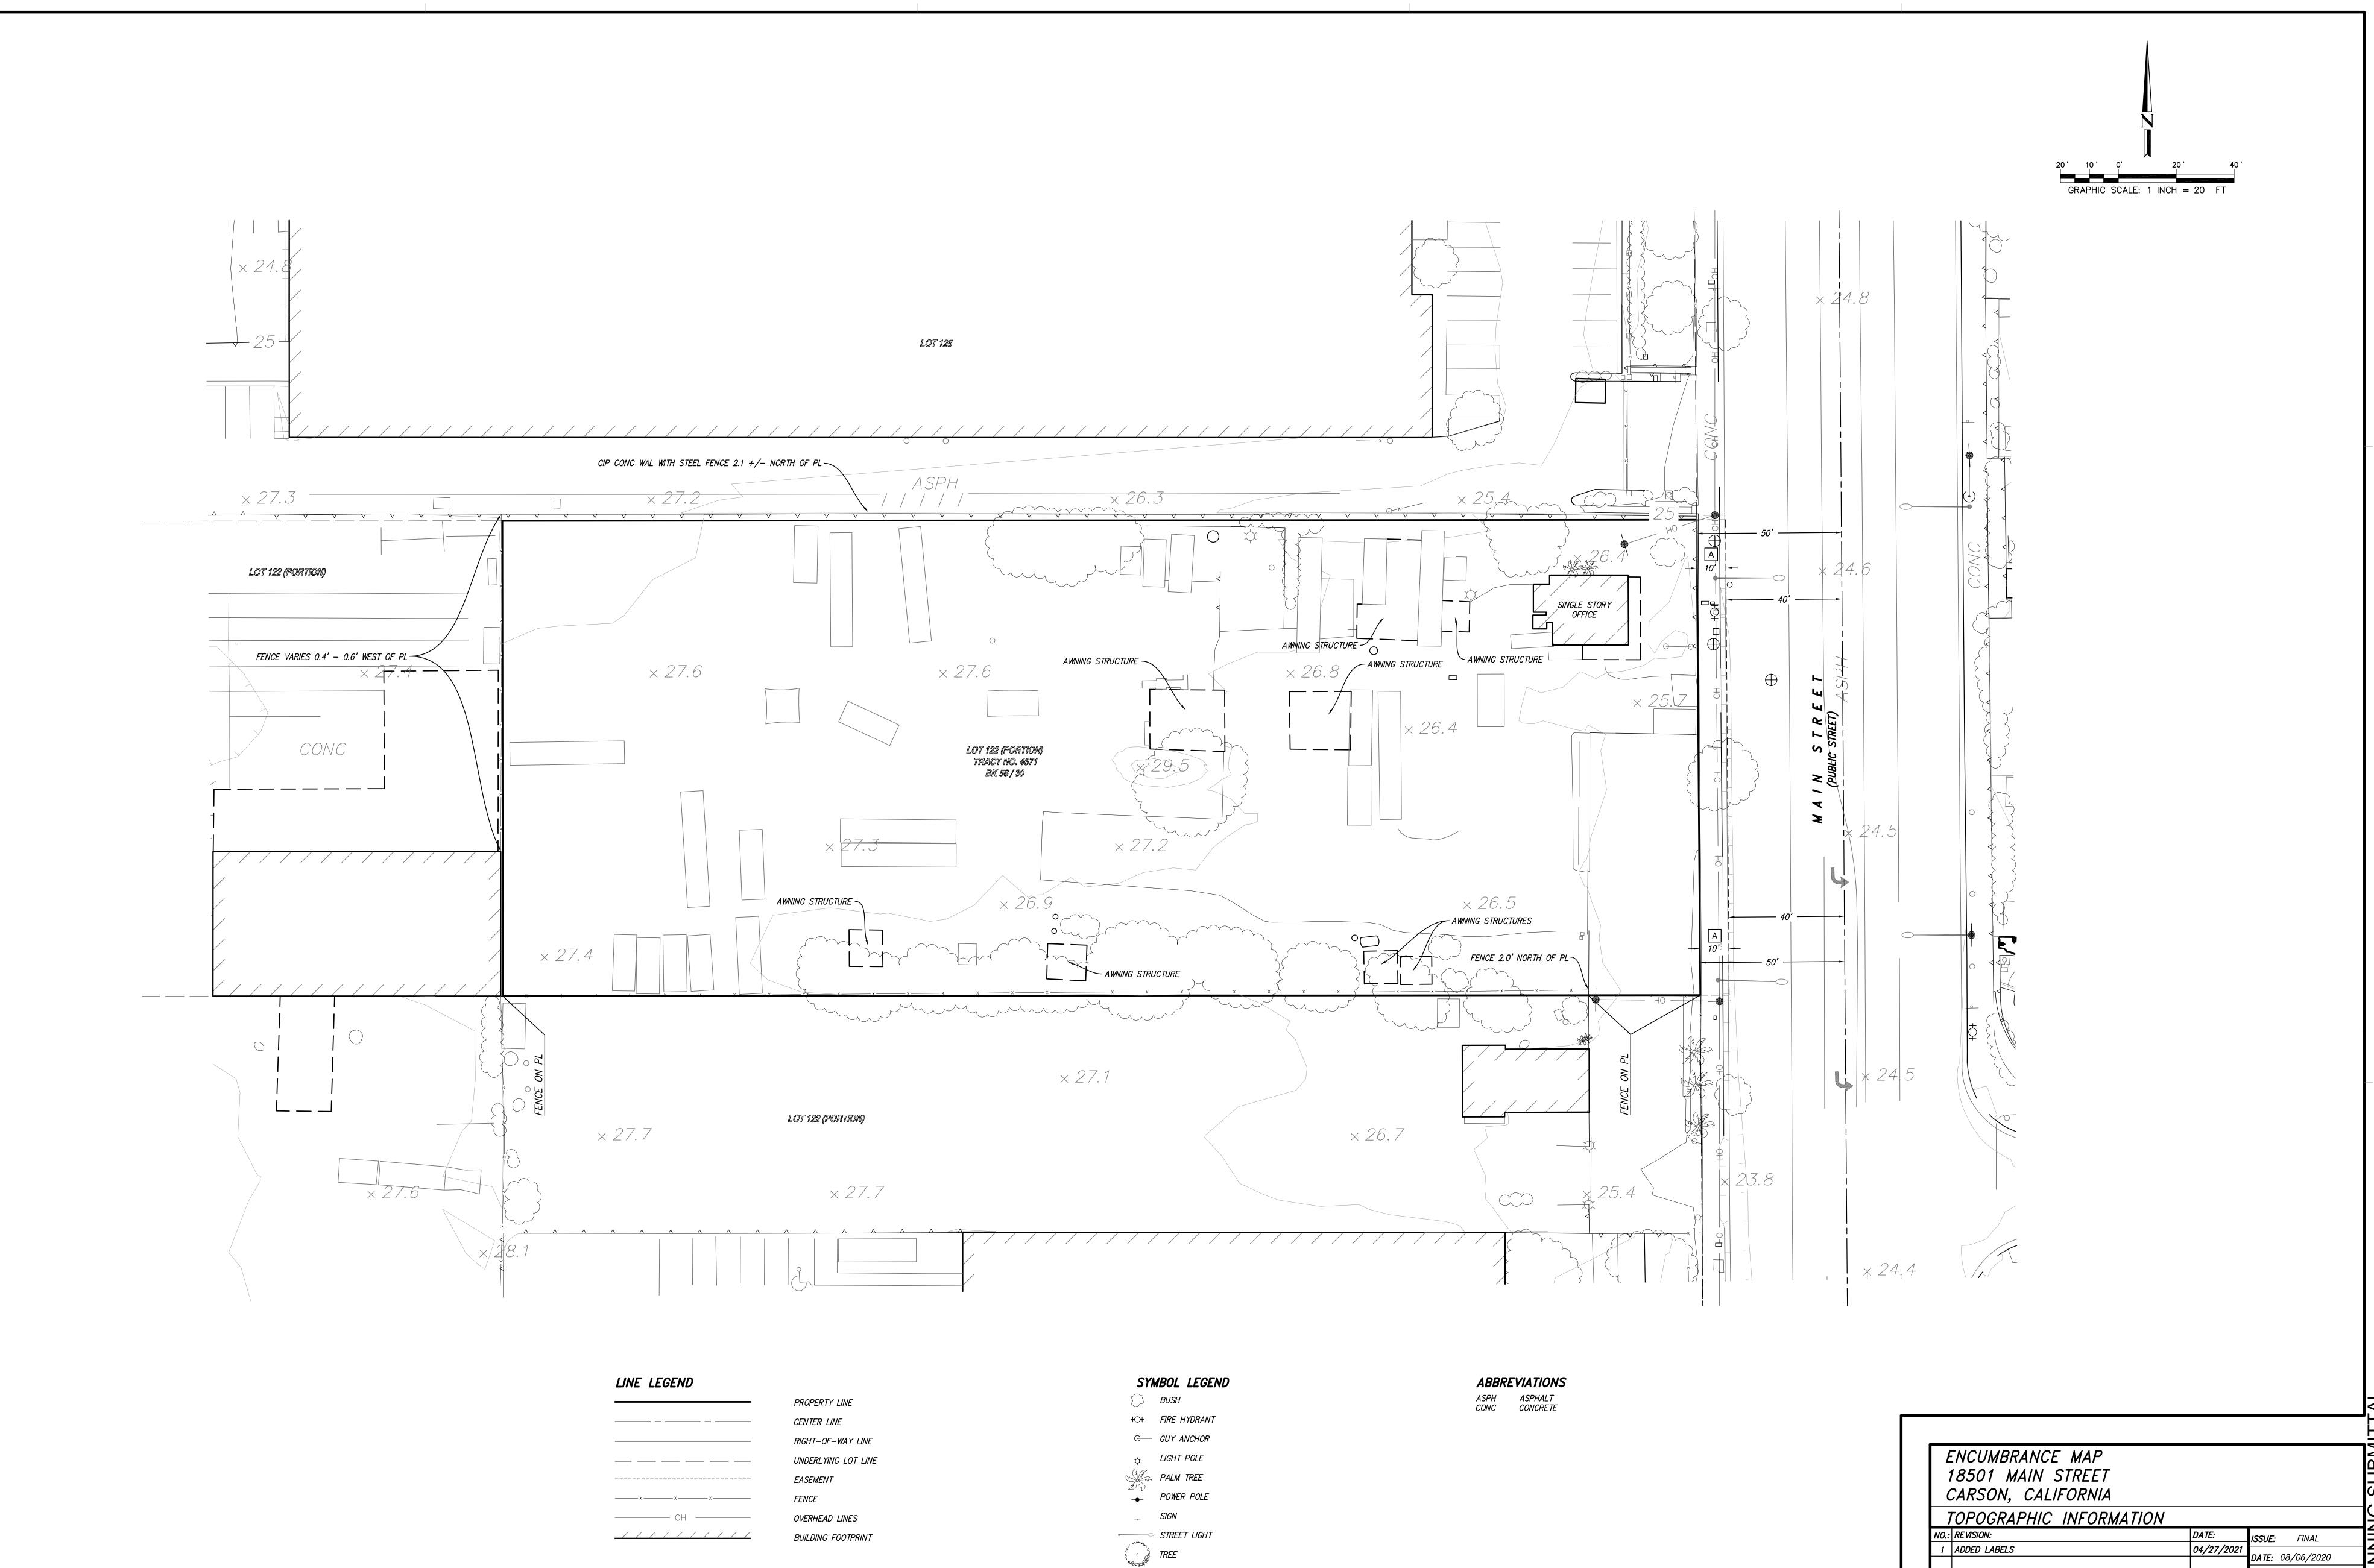

DATE: 08/06/2020 CHECKED: PRA DRAWN: MDS DRAWING FILE:20-543enc101 PROJECT NO.: 20−543 160 S. Old Springs Road, Ste. 210 SHEET NUMBER: Anaheim Hills, California 92808 (714) 685-6860 OF 2 SHEETS Civil Engineering/Land Surveying/Land Planning SCALE: 1" = 20'

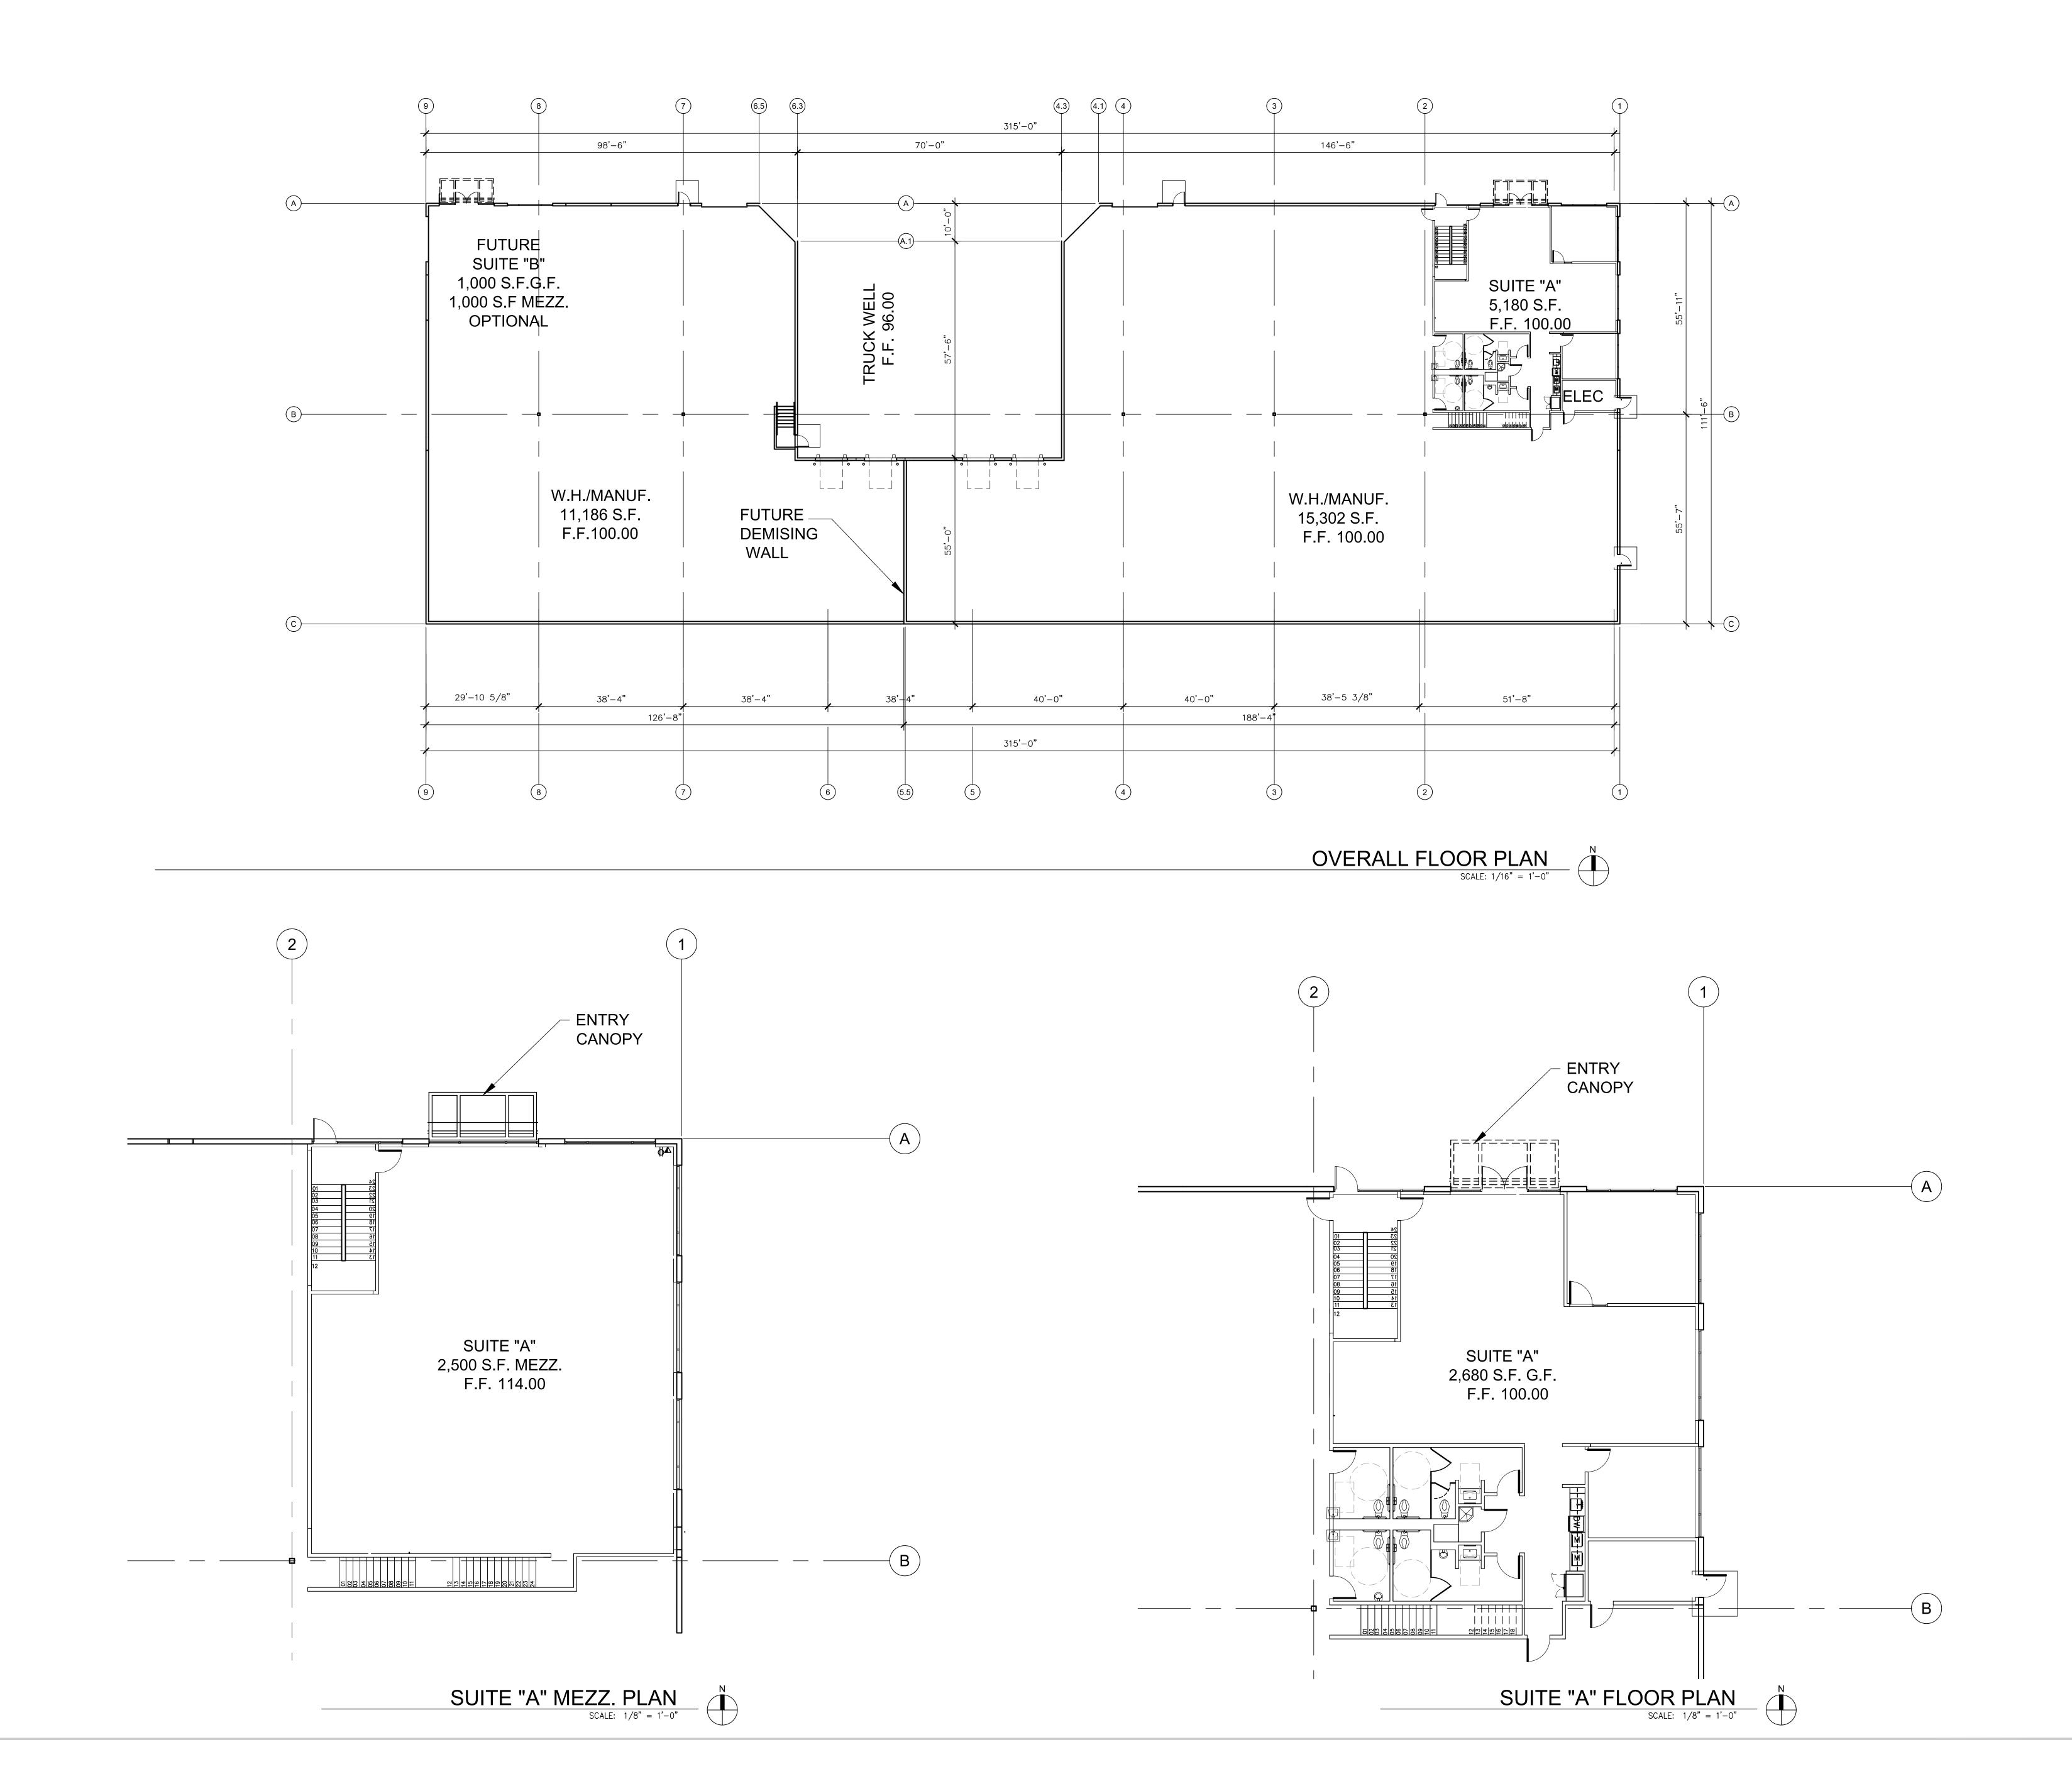

THE SCALED. THE DIMENSIONS LABELLED ON THESE DRAWINGS SHALL TWE PRECEDENCE OVER SCALED DIMENSIONS AND SHALL BE VERHEID AT THE JOBSTIE. ANY DISCREPANCIES SHALL SCALED. THE JOBSTIE. THE JOB

CONSULTANT

AIN STREET INDUSTRIAL
18501 MAIN STREET
CARSON, CA. 90746

for:

SSH HOLDINGS, LLC
50 W. FRANCISCO STREET LOS ANGELES, CA. 90501

PLAN ISSUE DATES

REV. DATE DESCRIPTION

CONCEPTUL DESIN REV1

CONCEPTUL DESIN REV2

CONCEPTUL DESIN REV2

CONCEPTUL DESIN REV2

CONCEPTUL DESIN RE-SUBMITTAL

Planning

05-26-21 SUBMITTAL

Planning

RE-SUBMITTAL

Planning

RE-SUBMITTAL

Planning


RE-SUBMITTAL

| 102-03-21 | REV2 | REV2 | CONCEPTUL DESIN | RE-SUBMITTAL | Planning | SUBMITTAL | Planning | RE-SUBMITTAL | Planning | R


MSA JOB NO.: 00-0000

FLOOR PLAN


A2.0

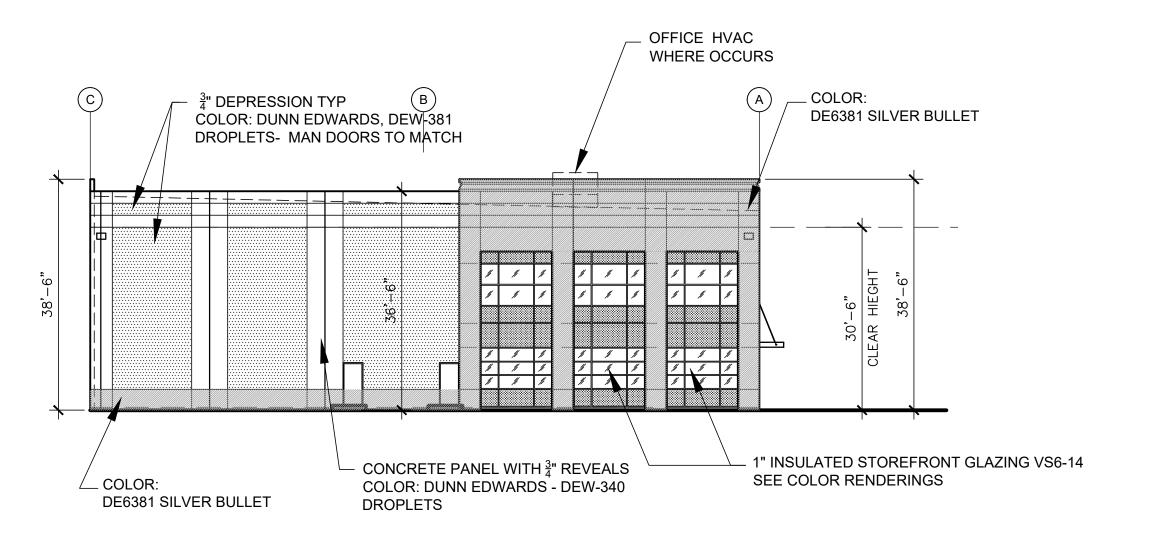


OVERALL EAST MAIN STREET ELEVATION SCALE: 1/16" = 1'-0"

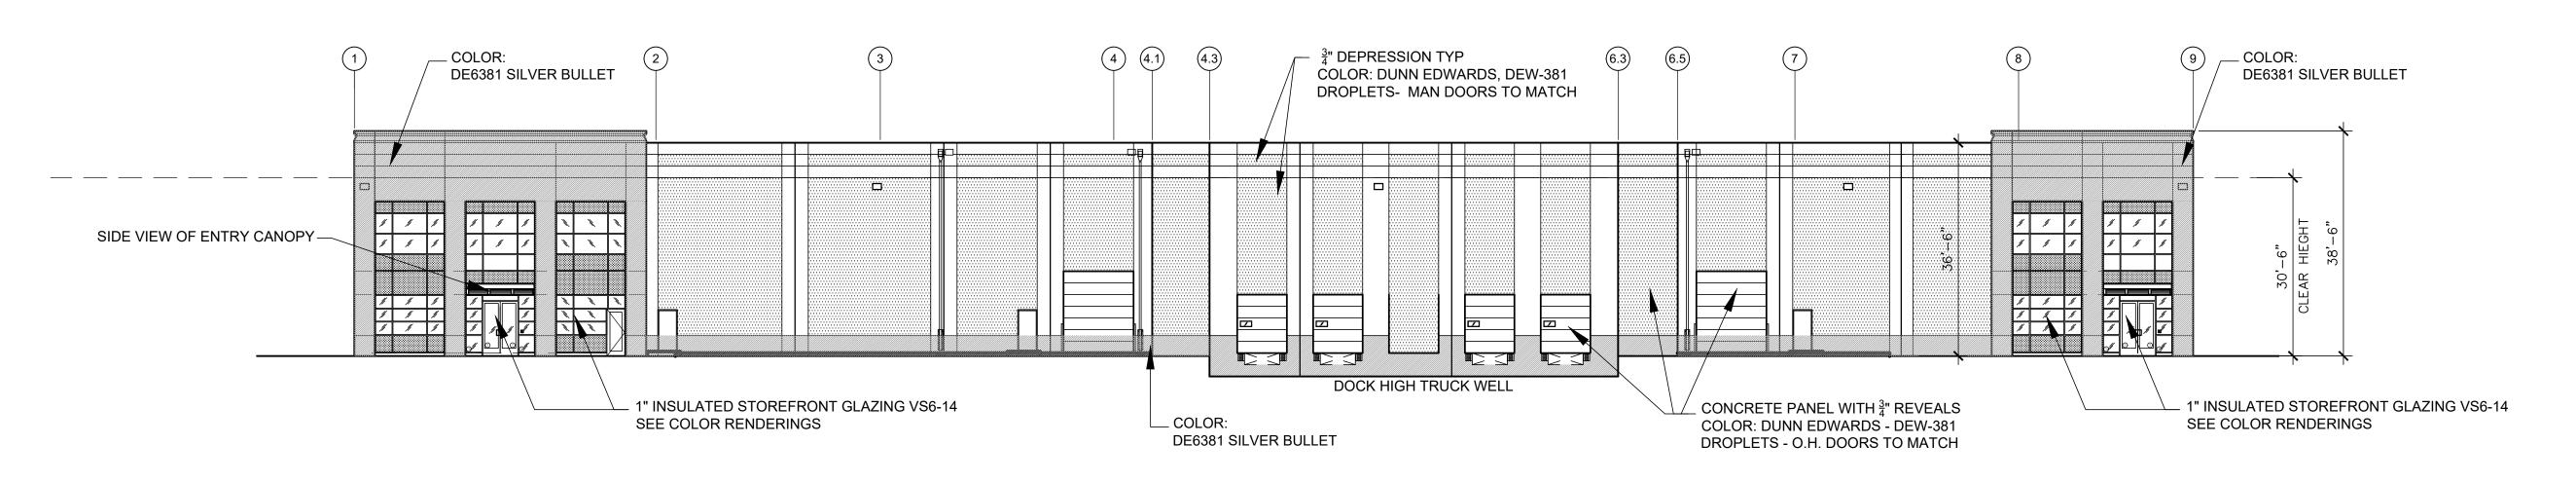

OVERALL NORTH ELEVATION SCALE: 1/16" = 1'-0"

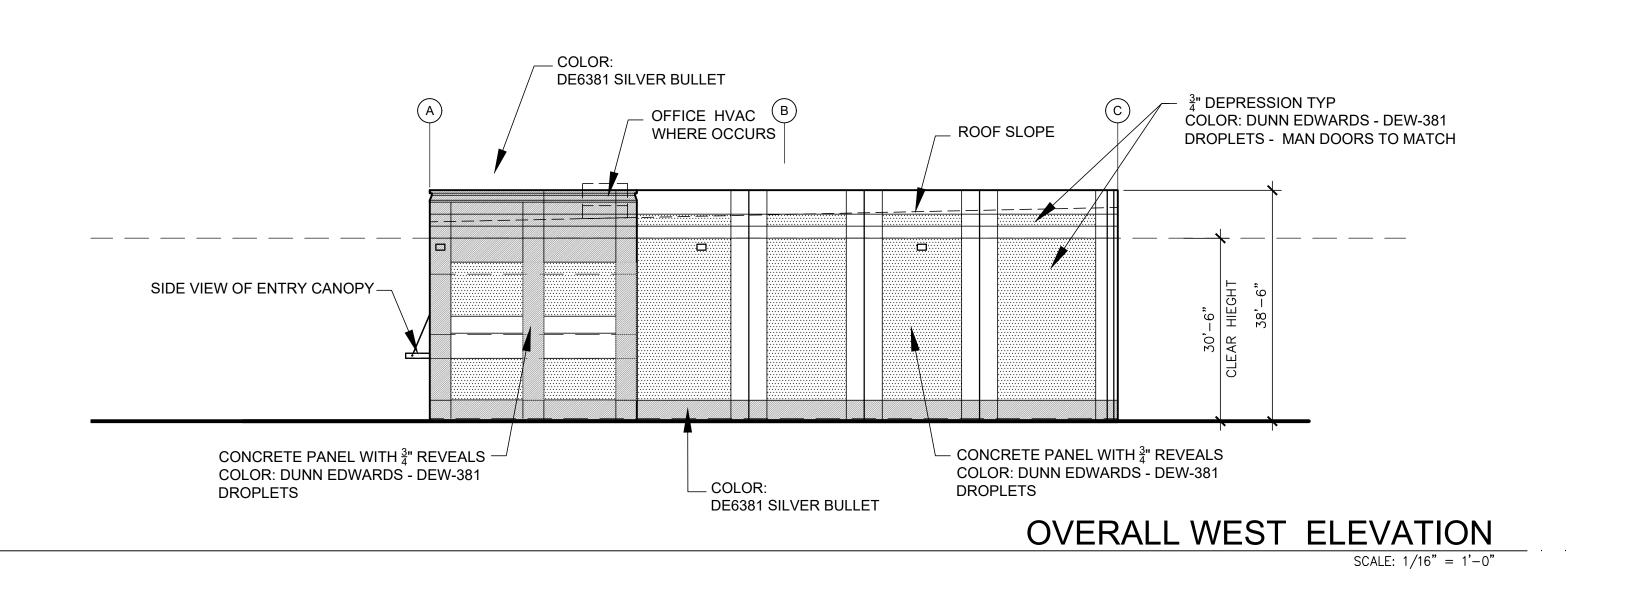

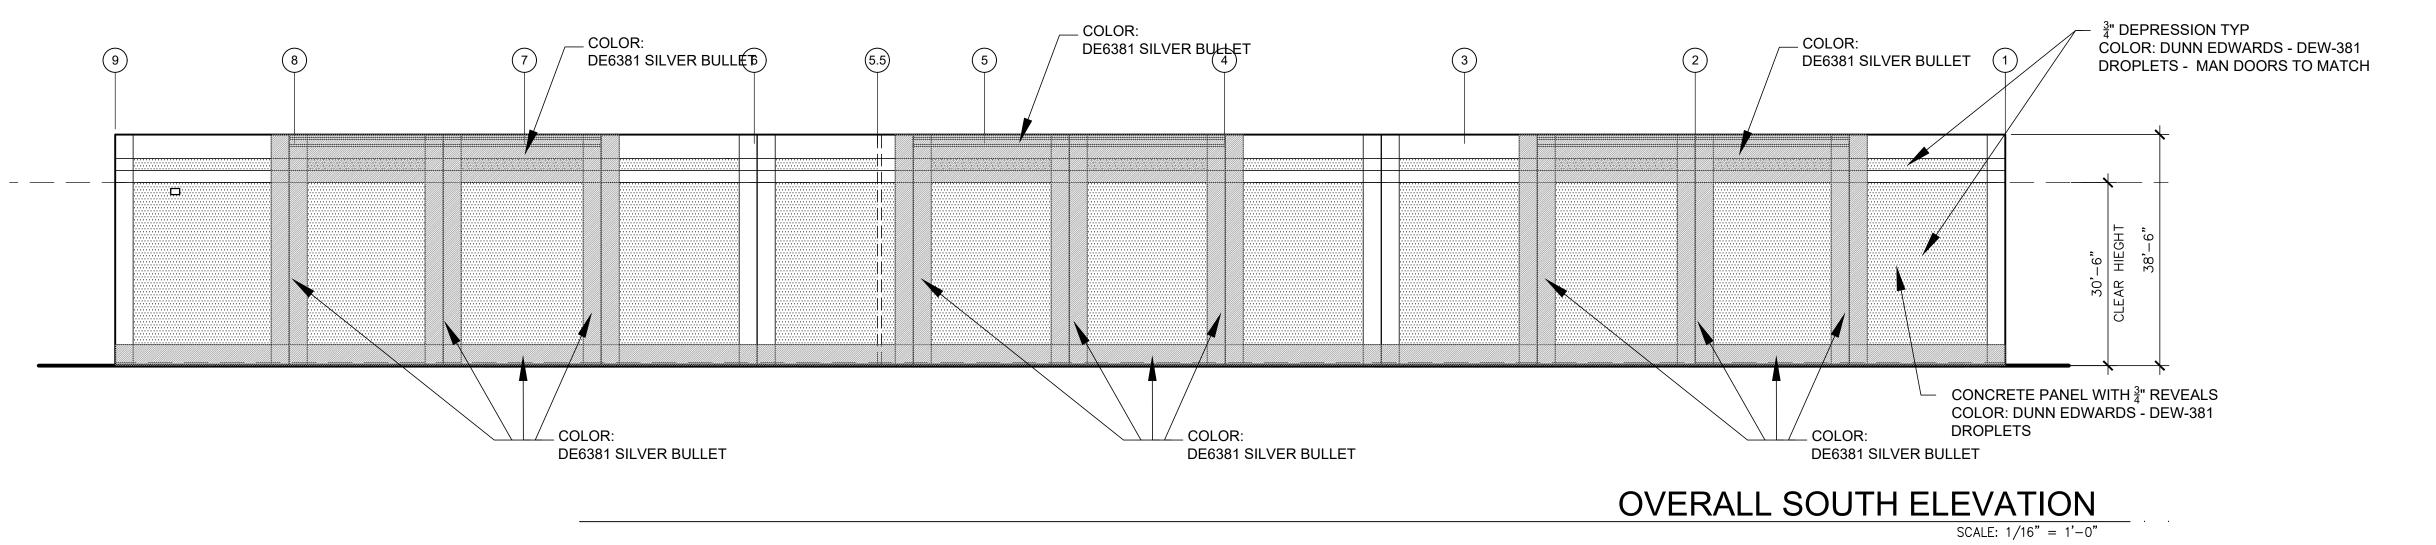

PROFESSIONAL STAMP

CONSULTANT

SSH 1450 W. FR/


PLAN ISSUE DATES REV. DATE DESCRIPTION

03-15-21 CONCEPTUL DESIN RE-SUBMITTAL Planning SUBMITTAL Planning

06-17-21 RE-SUBMITTAL

≅ PA/PM: DRAWN BY: REVIEWED BY: MSA JOB NO.: 00-0000

ELEVATIONS

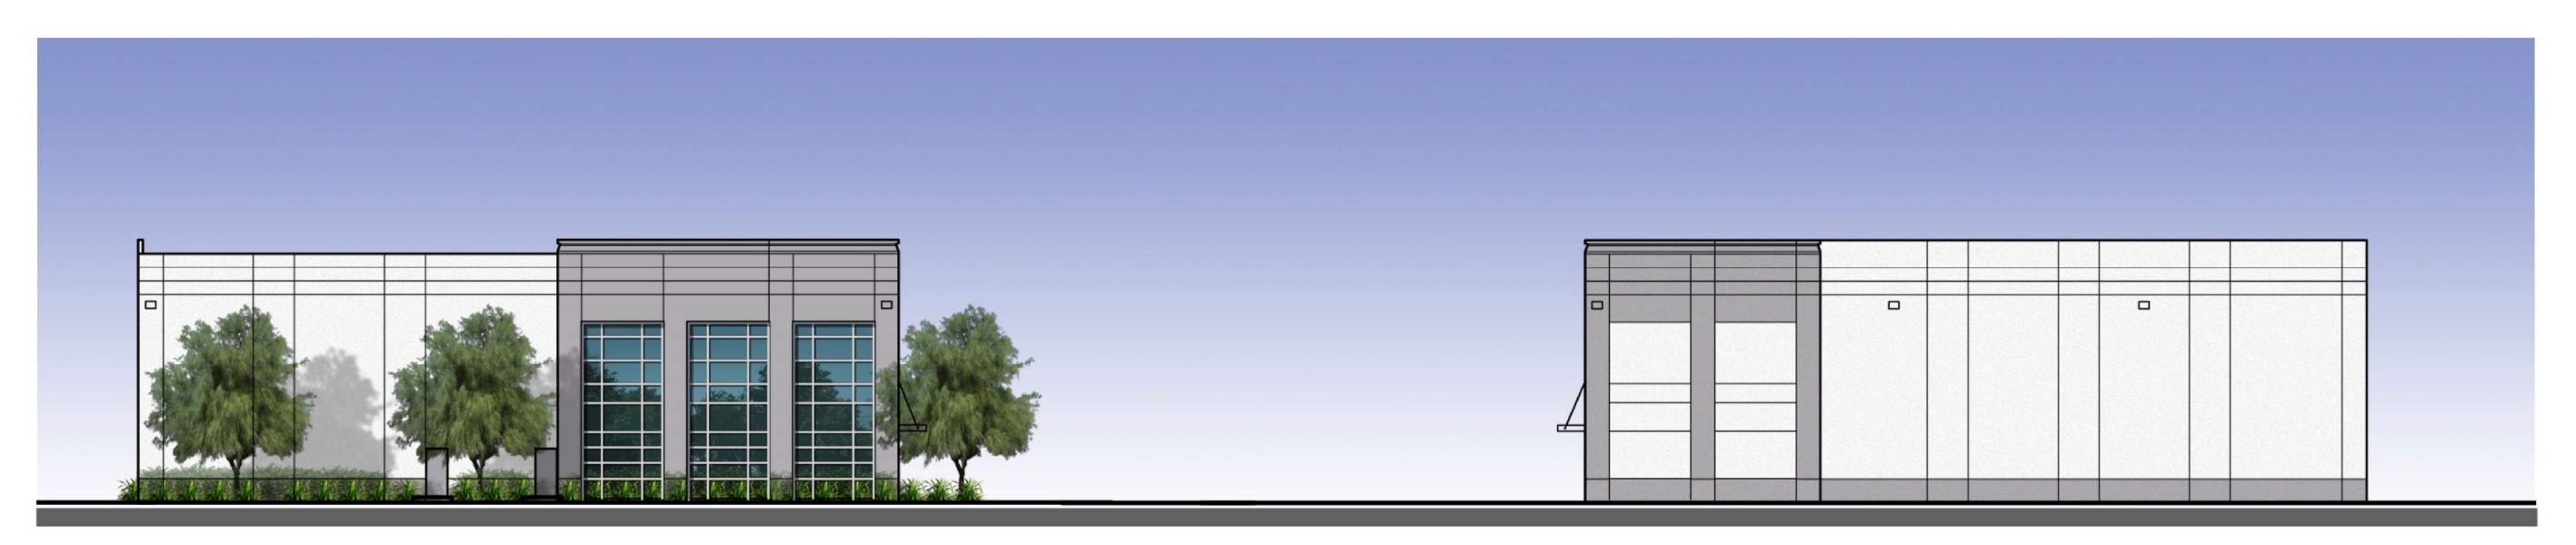

OVERALL EAST ELEVATION

OVERALL WEST ELEVATION



OVERALL SOUTH ELEVATION

Planning
Architectur
Interior
onstruction Managmen

23112 Alcalde Drive Suite "B" Laguna Hills, CA 92653

PROFESSIONAL STA

CONSULTA

18501 MAIN STREET CARSON, CA. 90746 for: SSH HOLDINGS, LLC

PLAN ISSUE DATES
EV. DATE DESCRIPTION

CONCEPTUL DESIN
REV1

CONCEPTUL DESIN
REV2

PM: MKS

MN BY: JRM

PM: MKS


WN BY: JRM


IEWED BY: MKS

JOB NO.: 00-0000

ELEVATIONS

A3.0

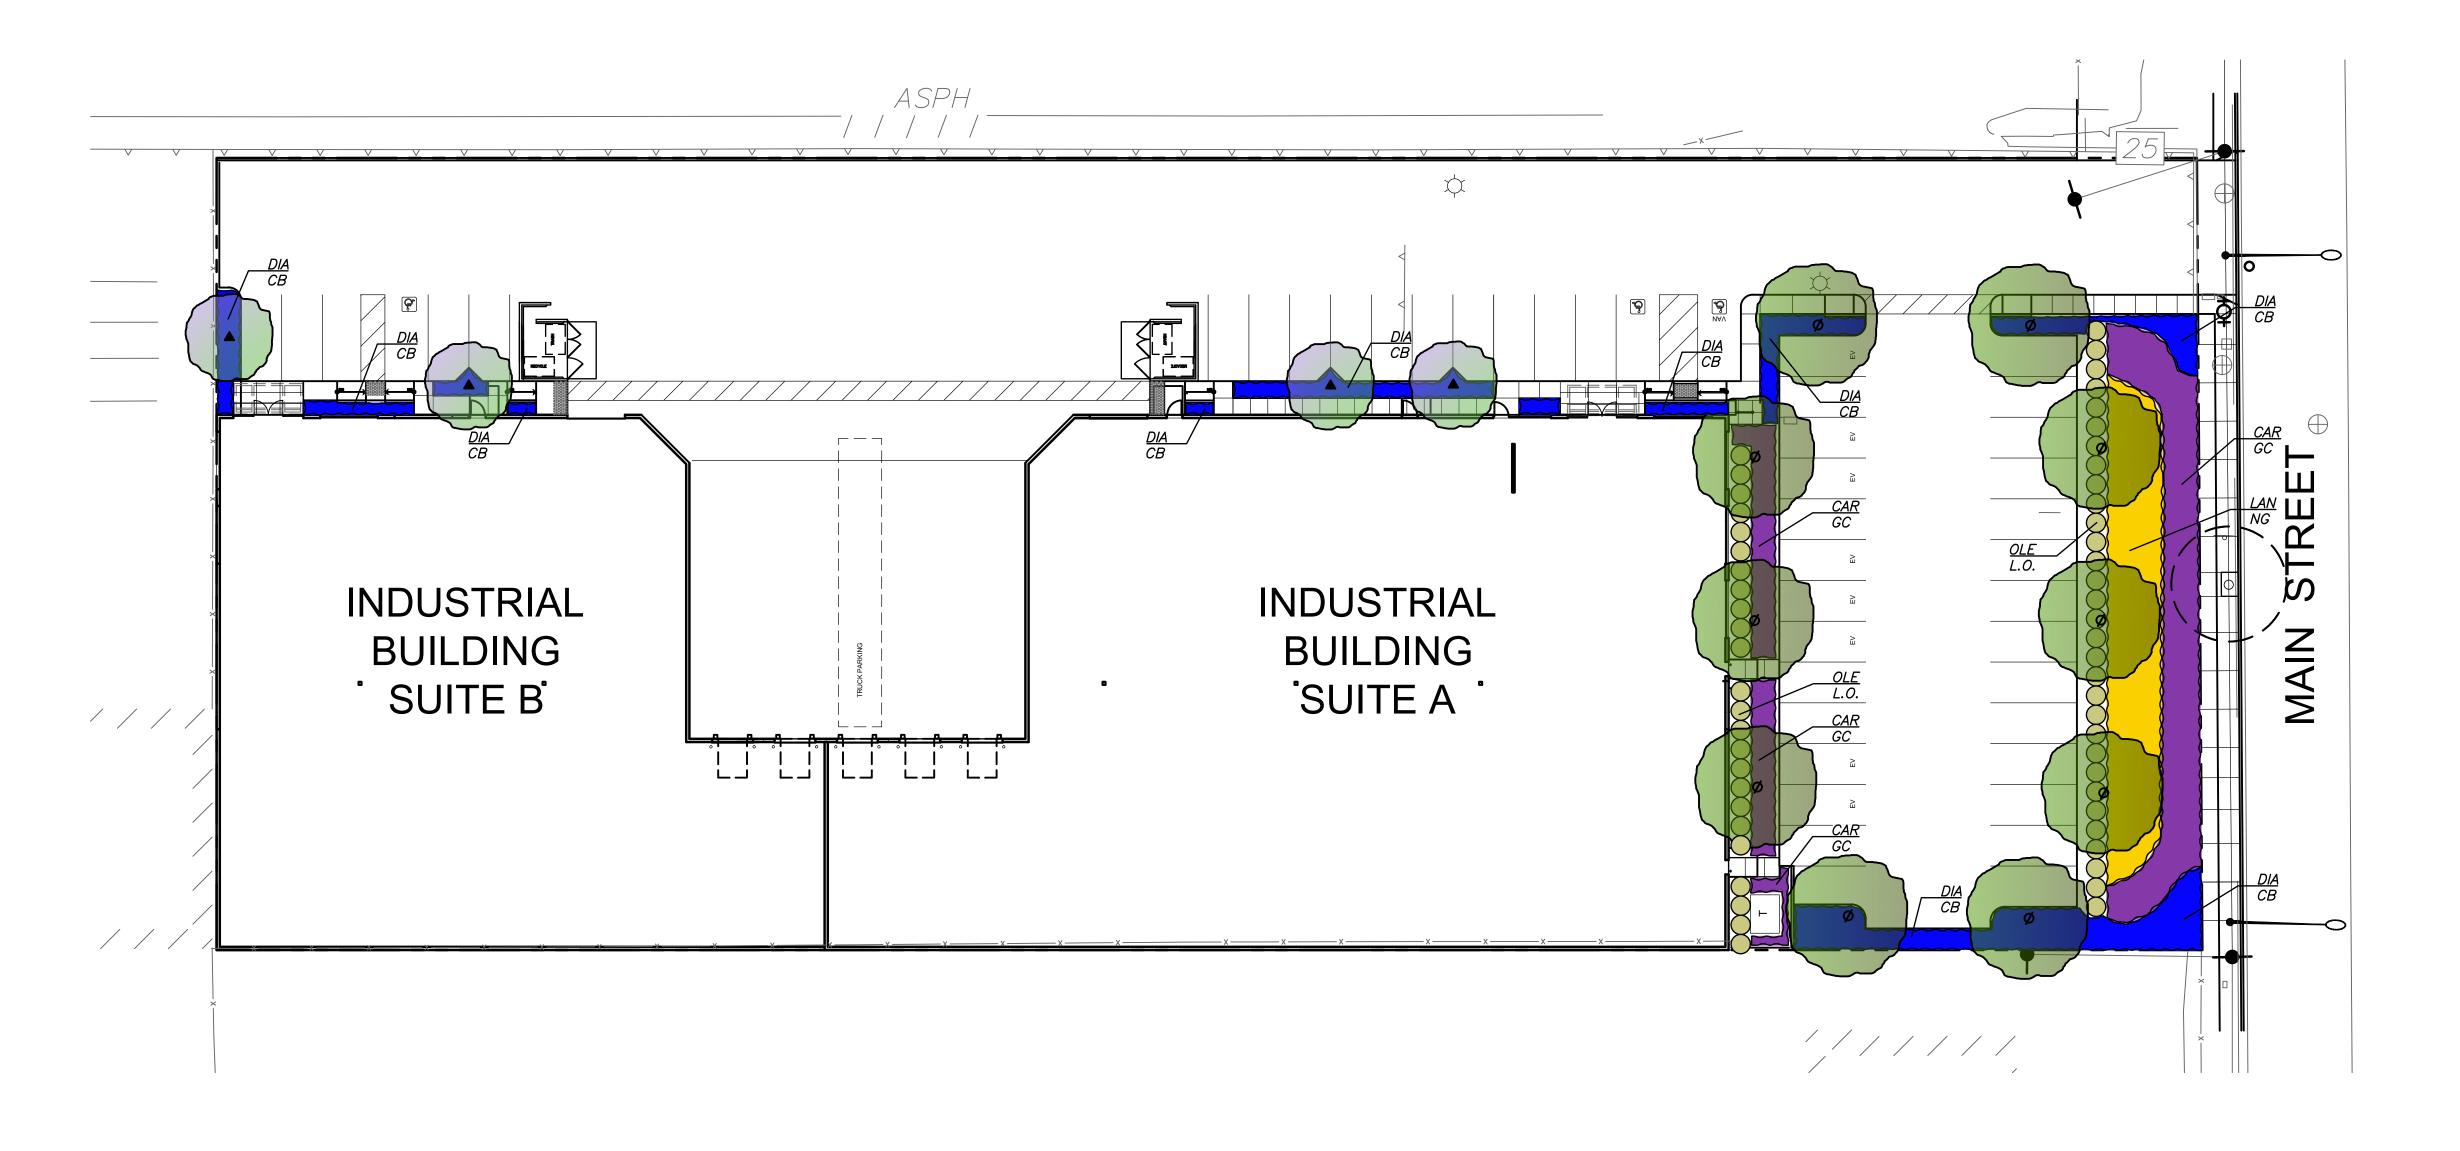

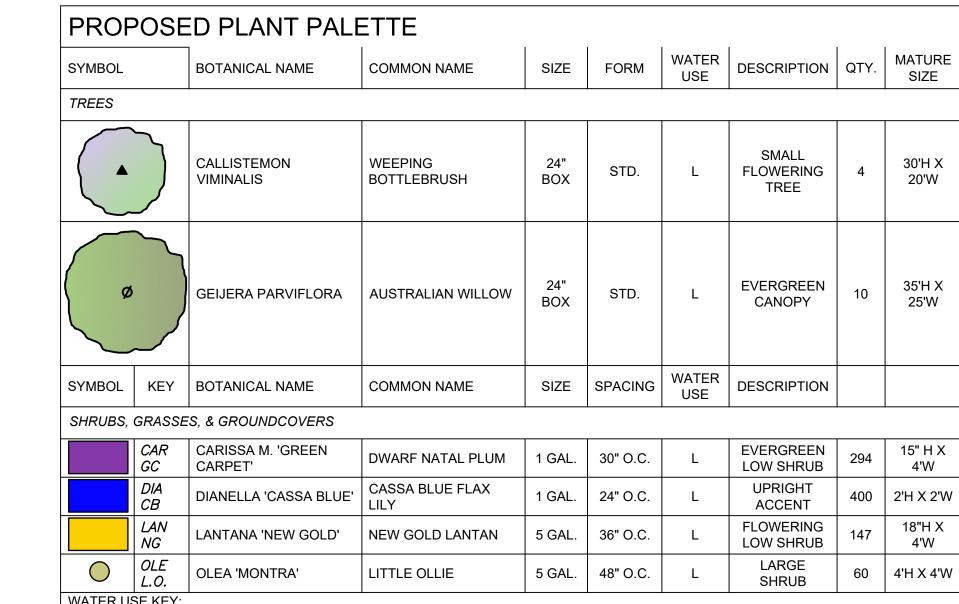





AUSTRALIAN WILLOW









OLEA 'MONTRA' / LITTLE OLLIE


PRELIMINARY LANDSCAPE PLAN


IRVINE - CA 92618

949.387.1323 RIDGELA.COM

PLAN ISSUE DATES


REV. DATE DESCRIPTION 12-03-20 SCHEMATIC DESIGN 04-27-21 PLAN CHECK REVISION

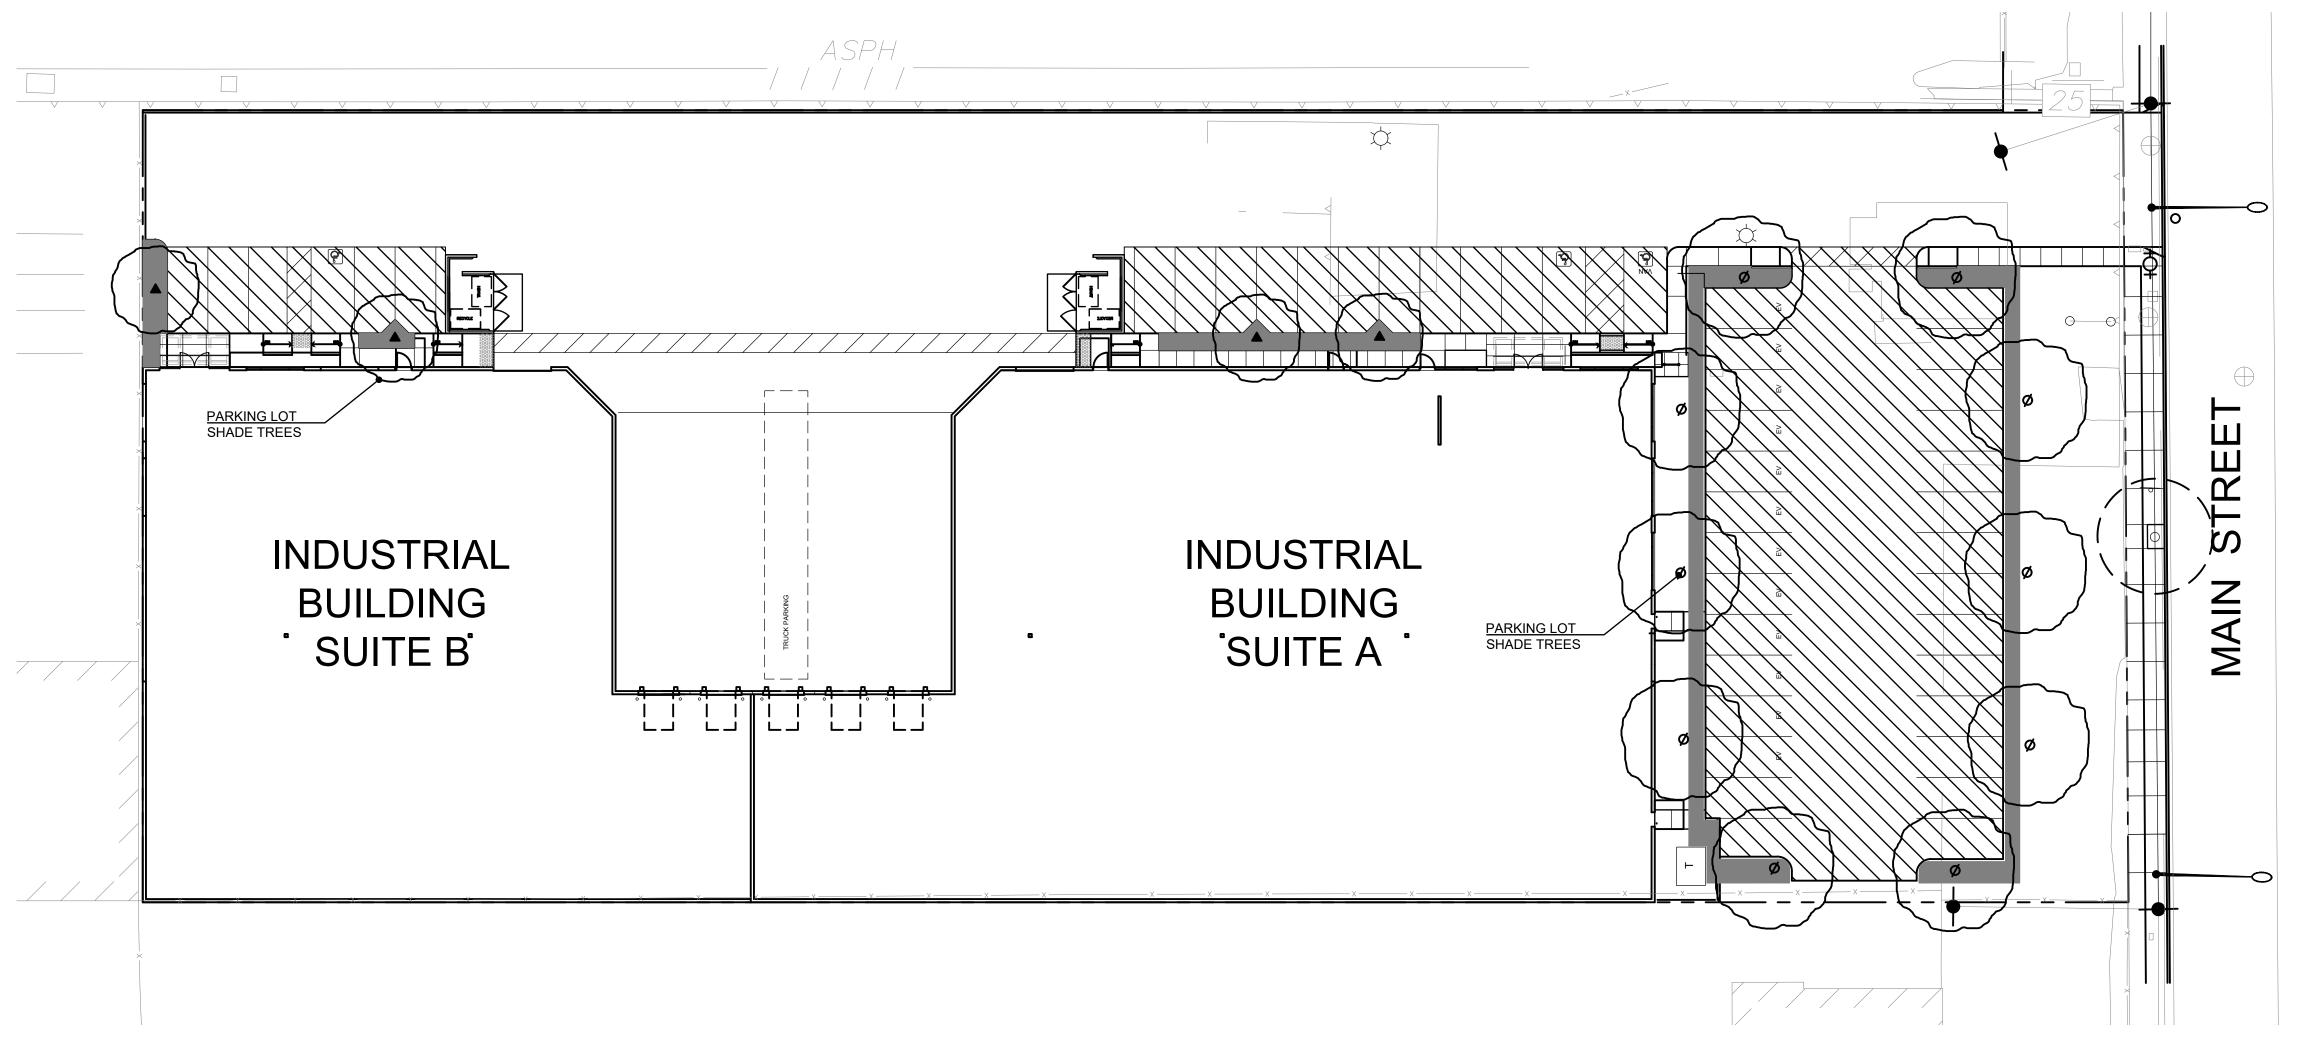

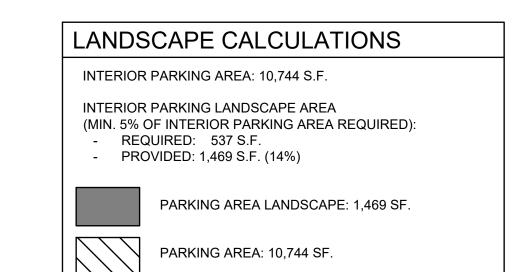

| PROPOSED TREE LEGEND | | | |
|--|--------------------------|------------------------|--|
| SYMBOL | BOTANICAL NAME | COMMON NAME | |
| TREES | | | |
| • | CALLISTEMON VIMINALIS | WEEPING BOTTLEBRUSH | |
| ø | GEIJERA PARVIFLORA | AUSTRALIAN WILLOW | |
| NOTE: TREE SYMBOLS SHOWN AS MATURE SIZE OF TREES AT 10 | | | |


PRELIMINARY LANDSCAPE CALCULATIONS PLAN

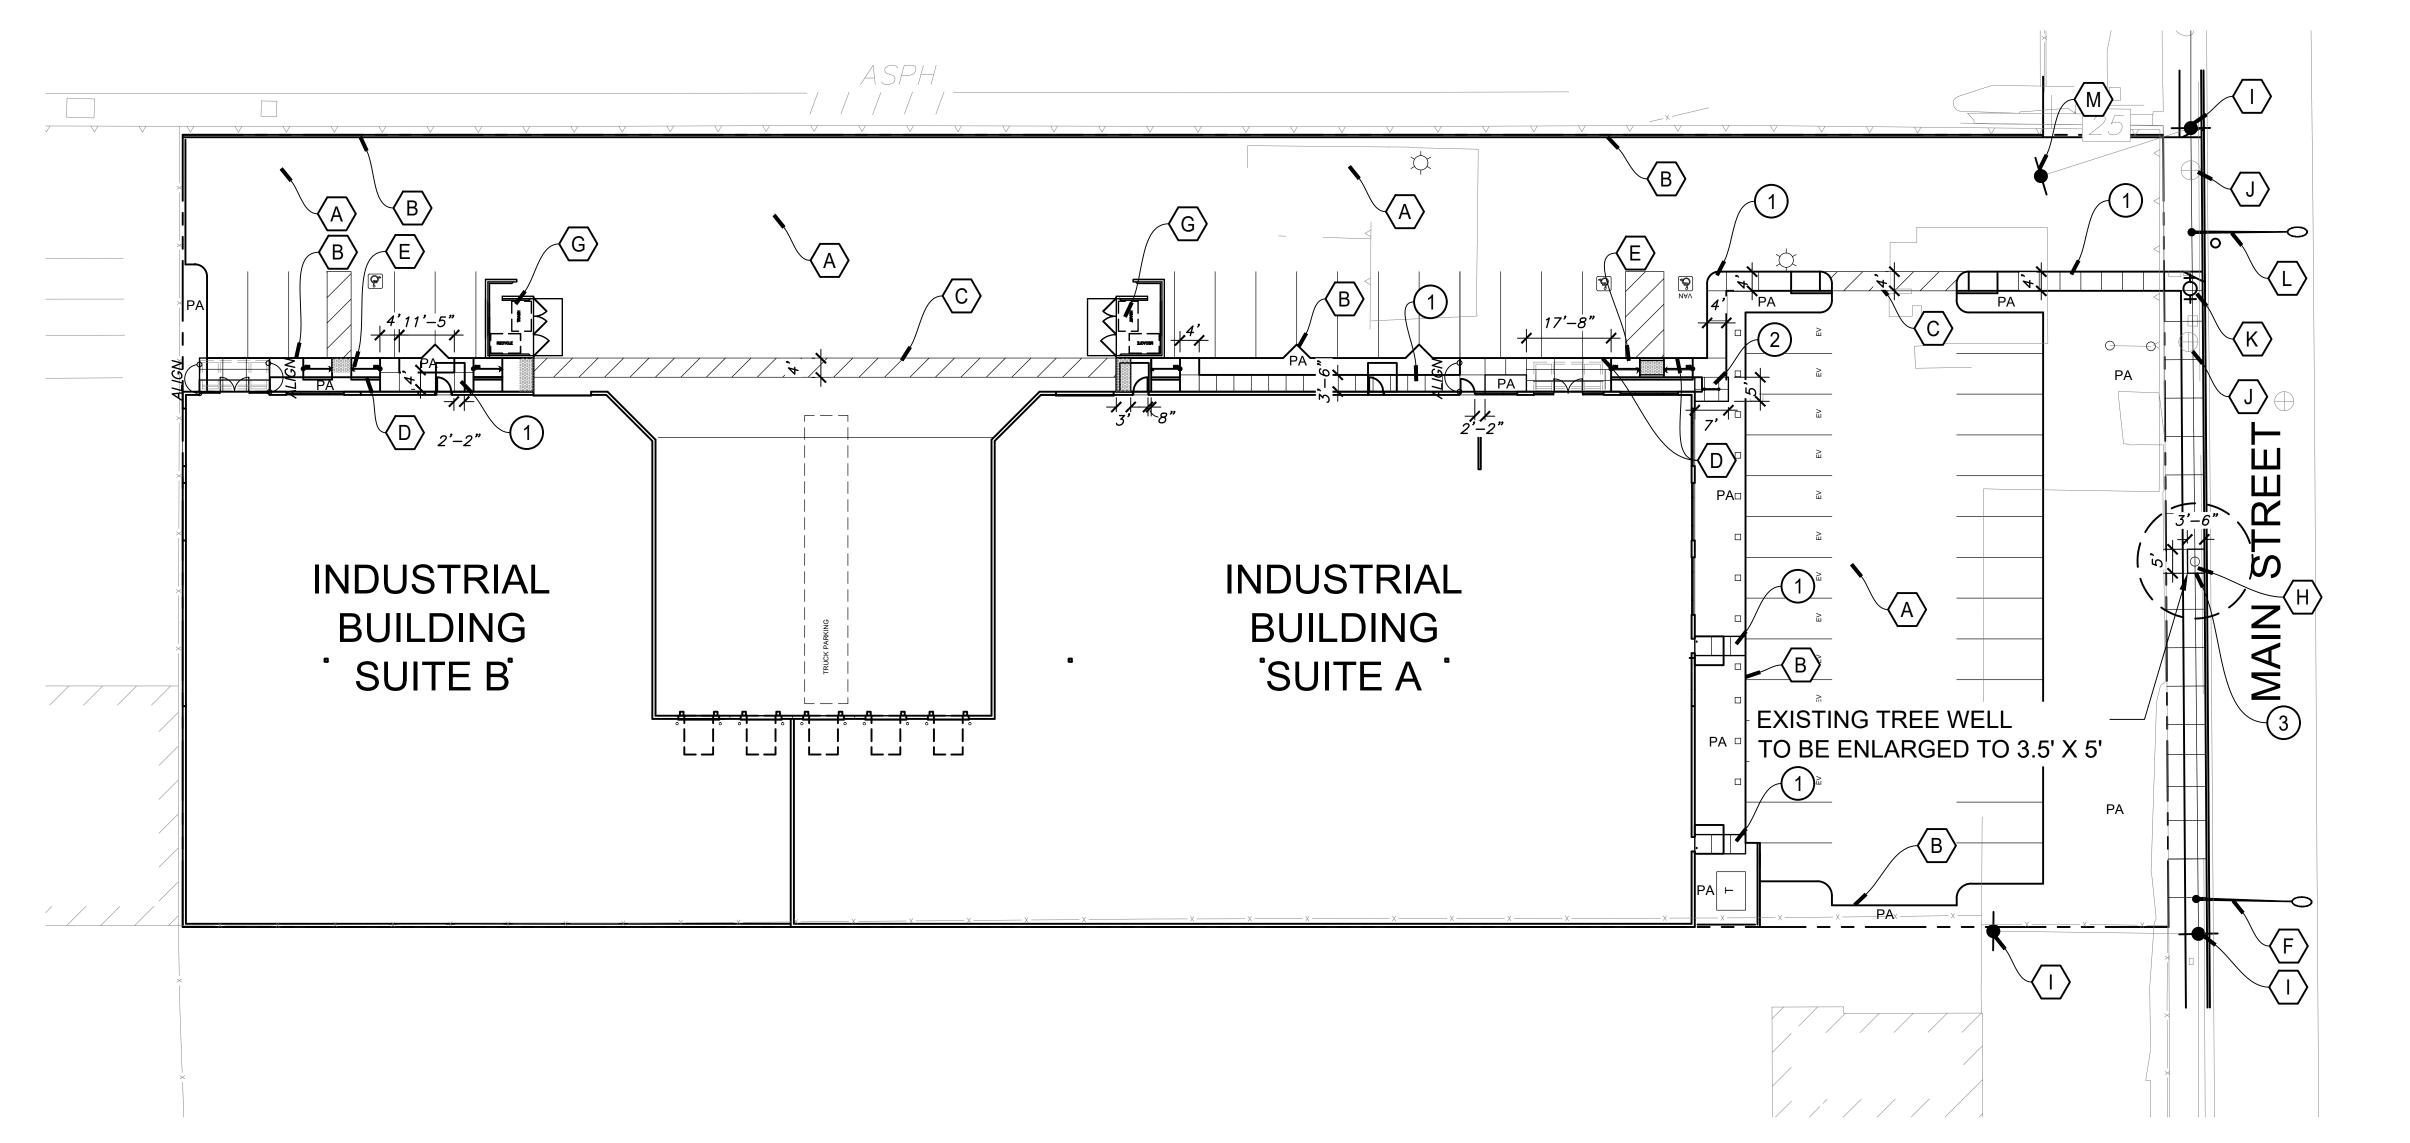

| HARDSCAPE KEYNOTES | | | |
|--------------------|---------------|--|--|
| KEY | DESCRIPTION | | |
| 1 | CONCRETE WALK | | |
| 2 | BIKE RACK | | |
| 3 | NEW TREE WELL | | |

| REFERENCE KEYNOTES | | | | |
|---------------------|----------------------------|-------------------------|--|--|
| KEY | DESCRIPTION | DETAIL | | |
| A | A.C. PAVING | PER CIVIL ENG. PLANS | | |
| $\langle B \rangle$ | CONCRETE CURB | PER CIVIL ENG. PLANS | | |
| C | PAVEMENT STRIPING | PER CIVIL ENG. PLANS | | |
| | ADA STALL SIGNAGE | PER CIVIL ENG. PLANS | | |
| E | ACCESSIBLE RAMP | PER CIVIL ENG. PLANS | | |
| F | (E) STREET LIGHT | TO REMAIN | | |
| (G) | TRASH ENCLOSURE | PER ARCH. PLANS | | |
| Ξ | (E) PODOCARPUS STREET TREE | TO REMAIN | | |
| | (E) POWER POLE | TO REMAIN | | |
| | (E) MANHOLE | TO REMAIN | | |
| K | (E) FIRE HYDRANT | TO REMAIN | | |
| | (E) STREET LIGHT | TO BE RELOCATED | | |
| $\langle M \rangle$ | (E) POWER POLE | TO BE RELOCATED | | |

| SYMBOL LEGEND | | | |
|---------------|-------------------|--|--|
| SYMBOL | DESCRIPTION | | |
| | CONTRACTION JOINT | | |
| PA | PLANTING AREA | | |

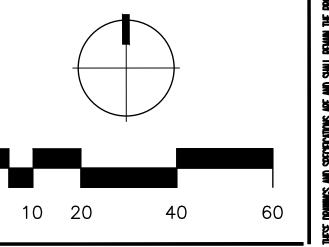





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PRELIMINARY LANDSCAPE AND PARKING CALCULATIONS

04-27-21 PLAN CHECK REVISION

| PA / PM: | RG |
|--------------|---------|
| DRAWN BY: | LA/RG |
| REVIEWED BY: | JR |
| MSA JOB NO.: | 00-0000 |

d ETWU (Annual Gallons

Eto x 0.62 x ETAF x Area

Where 0.62 is a conversion factor to change acre-inches per acre

per year to gallons per square

Required) =

foot per year

HYDROZONE LEGEND

DRIP HYDROZONE 1 (ZONE A) - LOW (5,693 SF.)

Appendix A Water Efficient Landscape Worksheet

| Reference Evapotranspiration (ET_0) | | 39.7 | Project Type | | Non-Residential | | 0.45 |
|--|--------------|---------------------|-------------------|---------|-----------------|-------------|---------------------|
| | | | | | | | Estimated Total |
| Hydrozone # | Plant Factor | Irrigation | Irrigation | ETAF | Landscape Area | ETAF x Area | |
| / Planting | (PF) | Method ^b | Efficiency | (PF/IE) | (Sq. Ft.) | | Water Use |
| Description ^a | | | (IE) ^c | | | | (ETWU) ^d |
| Regular Landscape Areas | | | | | | | |
| 1- Shrub Drip (LOW) | 0.3 | Drip | 0.81 | 0.37 | 5693 | 2109 | 51899 |
| | | | , | Totals | 5693 | 2109 | 51899 |
| Special Landscape Area | S | | | | | | |
| Totals 0 0 | | | | | 0 | | |
| ETWU Total d | | | | | 51,899 | | |
| Maximum Allowed Water Allowance (MAWA) e | | | | | 63,057 | | |

1.) Front lawn 2.) Low water use planting 2.) Drip 3.) Medium water use planting

^a Hydrozone# / Planting Description e.g. ^b Irrigation Method ^c Irrigation Efficiency 1.) Overhead Spray 1.) 0.73 for Spray Head 2.) 0.81 for Drip

Average ETAF for Regular Landscape

Areas must be 0.55 or below for

residential areas, and 0.45 or below

for non-residential areas.

^e MAWA (Annual Gallons Allowed) = (Eto) (0.62) [(ETAF x LA) + ((1-ETAF) x SLA)] Where 0.62 is a conversion factor to change acre-inches per acre per year to gallons per square foot per year, LA is the total regular landscape area in square feet, SLA is the total special landscape area in square feet, and ETAF is 0.55 for residential areas and 0.45 for nonresidential areas.

0.37 (B+D) ÷ (A+C)

ETAF Calculations Regular Landscape Areas Total ETAF x Area Total Area

0.37 Average ETAF All Landscape Areas 2109 (B+D) Total ETAF x Area 5693 (A+C) Total Area

Average ETAF

CITY OF CARSON MWELO NOTES

FINAL IRRIGATION PLANS WILL BE SUBMITTED WITH CONSTRUCTION DOCUMENTS AND WILL COMPLY WITH ALL CITY OF CARSON MWELO REQUIREMENTS INCLUDING:

ALL PLANTS ARE LOW WATER USE.

ALL PLANTING AREAS HAVE A PLANT FACTOR OF 0.3.

IRRIGATION WILL BE IN-LINE DRIP TUBING WITH AN IRRIGATION EFFICIENCY OF .81.

AGRONOMIC SOILS TESTING WILL BE DONE AFTER MASS GRADING IS COMPLETE AND WILL BE SUBMITTED WITH CERTIFICATION OF COMPLETION.

THERE IS ONLY (1) HYDROZONE PROPOSED. ALL PLANTS ARE LOW WATER USE. NO INVASIVE PLANTS ARE PROPOSED. THE PLANT LIST HAS

BEEN REVIEWED AGAINST THE CALIFORNIA INVASIVE PLANT COUNCIL'S "DON'T PLANT A PEST" BROCHURE. PLANT FACTORS USED ON THE PLANT LEGEND ARE NOTED

FROM WUCOLS. MATURE PLANT SPREAD IS NOTED FROM 'SUNSET WESTERN GARDEN'.

PRESSURE REGULATING DEVICES ARE REQUIRED IS WATER PRESSURE IS BELOW OR EXCEEDS THE RECOMMENDED PRESSURE OF THE SPECIFIED IRRIGATION DEVICES.

CHECK VALVES OR ANIT-DRAIN VALVES ARE REQUIRED ON ALL SPRINKLER HEADS WHERE LOW POINT DRAINAGE COULD

WATER CONSERVATION NOTES

THE FOLLOWING WATER CONSERVATIN TECHNIQUES SHALL BE EMPLOYED IN THIS PROJECT:

- A. WATER CONSERVING PLANTS AND PLANTS NATIVE TO HOT, DRY SUMMERS TO BE UTILIZED IN 75% OF THE TOTAL PLANTED AREA.
- B. USE OF HYDROZONES WITH PLANTS GROUPED BASED
- C. MULCH 3/4" 1" SIZE UTILIZED IN THE LANDSCAPE; 3" DEPTH MINIMUM.
- SEASONALLY AND WITH WATERING HOURS BETWEEN 10:00 P.M. AND 6:00 A.M.
- AREAS OF THE LANDSCAPE BASED ON WATERING NEED.
- J. LANDSCAPE WATER USE CERTIFICATION WITH SUPPORTING DATA IN COMPLIANCE WITH STATE OF CALIFORNIA WATER EFFICIENCY ORDINANCE FOR APPROVAL SHALL BE SUBMITTED WITH LANDSCAPE
- WITH ALL EQUIPMENT SUITABLE FOR THE USE OF RECLAIMED WATER AND HEALTH DEPARTMENT REQUIREMENTS RELATIVE TO RECLAIMED USE WILL
- L. ONLY LOW VOLUME OR SUBSURFACE IRRIGATION SHALL BE USED TO IRRIGATE ANY VEGETATION WITHIN TWENTY-FOUR INCHES OF AN IMPERMEABLE SURFACE UNLESS THE ADJACENT IMPERMEABLE SURFACES ARE DESIGNED AND CONSTRUCTED TO CAUSE WATER TO



UPON AMOUNT OF WATER NEEDED TO SUSTAIN THEM.

D. SOIL AMENDMENTS UTILIZED TO IMPROVE WATER HOLDING CAPACITY OF SOIL.

E. AUTOMATIC IRRIGATION SYSTEM ADJUSTED

F. IRRIGATION SYSTEM DESIGNED TO WATER DIFFERENT

G. IRRIGATION DESIGN SENSITIVE TO SLOPE FACTORS.


H. RAIN SENSORS USED IN CONJUNCTION WITH THE AUTOMATIC IRRIGATION SYSTEM.


RECOMMENDATIONS GIVEN FOR ANNUAL IRRIGATION SCHEDULE.

CONSTRUCTION DOCUMENT SUBMITTAL TO THE CITY.

K. AN AUTOMATIC IRRIGATION SYSTEM WILL BE PROVIDED APPLY TO THE PROJECT.

DRAIN ENTIRELY INTO A LANDSCAPED AREA.

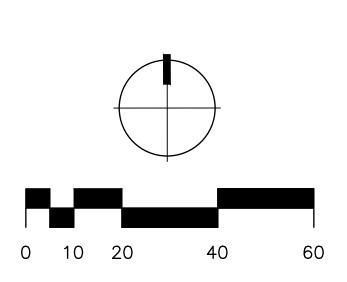

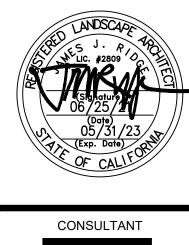



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CONCEPTUAL WATER CONSERVATION

PLAN ISSUE DATES REV. DATE DESCRIPTION 12-03-20 SCHEMATIC DESIGN

04-27-21 PLAN CHECK REVISION